INDEX OF SHEETS

ACRONYMS AND ABBREVIATIONS DESCRIPTION

AC AIT (TL-2)

ЙМА

Horiz HP

Temp Trans

Var Vert

AGGREGATE BASE ASPHALT CONCRETE ALTERNATIVE IN-LINE TERMINAL

GINNING OF BRIDGE GIN HORIZONTAL CURVE/

BEGIN VERTICAL CURVE

DIAMETER
EAST
END OF BRIDGE
END HORIZONTAL CURVE
EROSION CONTROL
ELEVATION
EDGE OF PAVEMENT
END VERTICAL CURVE

MIDWEST GUARDRAIL SYSTEM NUMBER OBLITERATE OVERHEAD

GROUND E DRAIN

RADIUS ROCK SLOPE PROTECTION RIGHT

COMPOUND CURVE INFLECTION BEGIN END

REVERSE CURVE

TANGENT
TELECOMMUNICATION
TEMPORARY CONSTRUCTION
EASEMENT
TEMPORARY HIGH VISIBILITY FENCE
TEMPORARY

HOT MIX ASPHALT HORIZONTAL HINGE POINT LEFT

OVERHEAD
ORIGINAL O
OVERSIDE
POINT OF
POINT OF
POINT OF
POINT OF
POINT OF
POINT OF

SHOULDER SOUTH

TRANSITION

CHAIN LINK CALTRANS DIAMETER

ORRUGATED STEEL PIPE


SHEET NO.	PAGE NO.	DESCRIPTION
T1	1	TITLE SHEET
L1	2	PLAN, PROFILE, AND TYPICAL SECTION
S1	3	SUPERELEVATION DIAGRAM
C1	4	CONSTRUCTION DETAILS
G1	5	CONTOUR GRADING PLAN
U1	6	UTILITY PLAN
CA1	7	CONSTRUCTION AREA SIGNS
SC1-SC2	8-9	TRAFFIC HANDLING PLAN
PD1	10	SIGNING AND STRIPING PLAN
EC1	11	EROSION CONTROL PLAN
S1_S16	12-27	BRIDGE DLANS


STATE OF CALIFORNIA **COUNTY OF TULARE**

PROJECT PLANS FOR CONSTRUCTION OF

MOUNTAIN ROAD 109 (M109) OVER WHITE RIVER BRIDGE REPLACEMENT

FEDERAL PROJECT NO. BRLS-5946(170) BRIDGE NO. 46C-0487 OLD BRIDGE NO. 46C-0133 HIGHWAY BRIDGE PROGRAM (HBP)

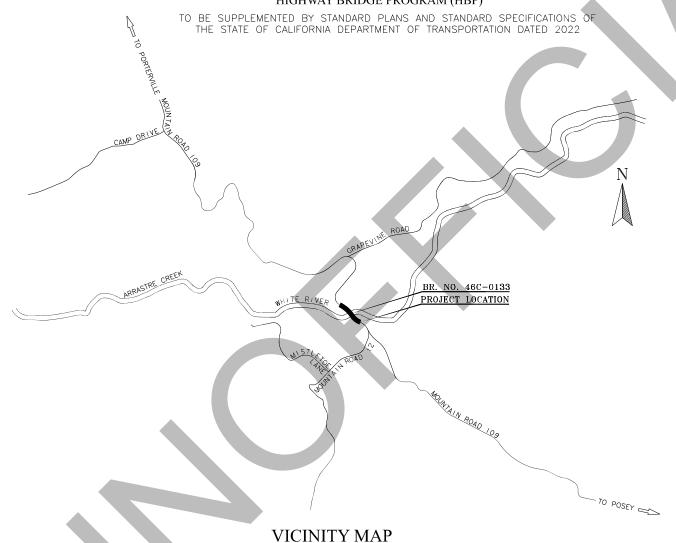

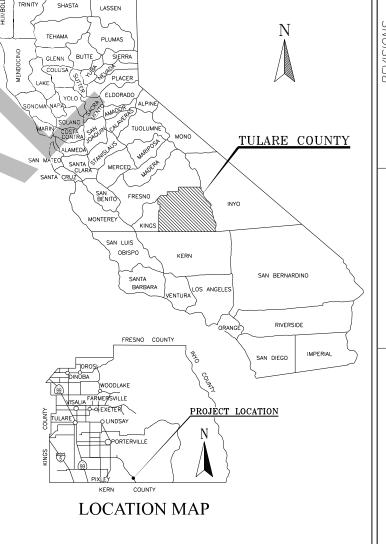

APPROVED BY:

DATE:

морос

DENNIS TOWNSEND, CHAIR TULARE COUNTY BOARD OF SUPERVISORS

DATE: 9/11/23

TULARE COUNTY RESOURCE MANAGEMENT AGENCY

(760) 375-6616

F3BDRIA ROBERT BURNS, P.E., PROJECT MANAGER DOKKEN ENGINEERING



BASIS OF BEARING AND COORDINATES

HORIZONTAL DATUM: NAD 83 CALIFORNIA ZONE 4 AS ADJUSTED TO NGS PID DH6642.

VERTICAL DATUM: NAVD 88 AS ADJUSTED TO NGS PID DH6642 ELEVATION = 276.2 FEET.

POINT #	ELEVATION	NORTHING	EASTING	DESCRIPTION
1	1091.04	1814949.04	6607729.95	60D
2	1082.35	1815078.32	6607501.39	60D
4	1079.23	1815185.43	6607446.75	MAG
7	1086.62	1815372.15	6607182.16	60D/IN TURNOUT



LEWIS EDROZO

UTILITY CONTACTS


FRONTIER COMMUNICATIONS


811 two working days prior

MOUNTAIN ROAD 109 (M109) OVER WHITE RIVER BRIDGE REPLACEMENT SCALE AS SHOWN DIVISION JOB NO. DESIGNED **K**.

RAWN HECKED KK DATE

\$DATE\$

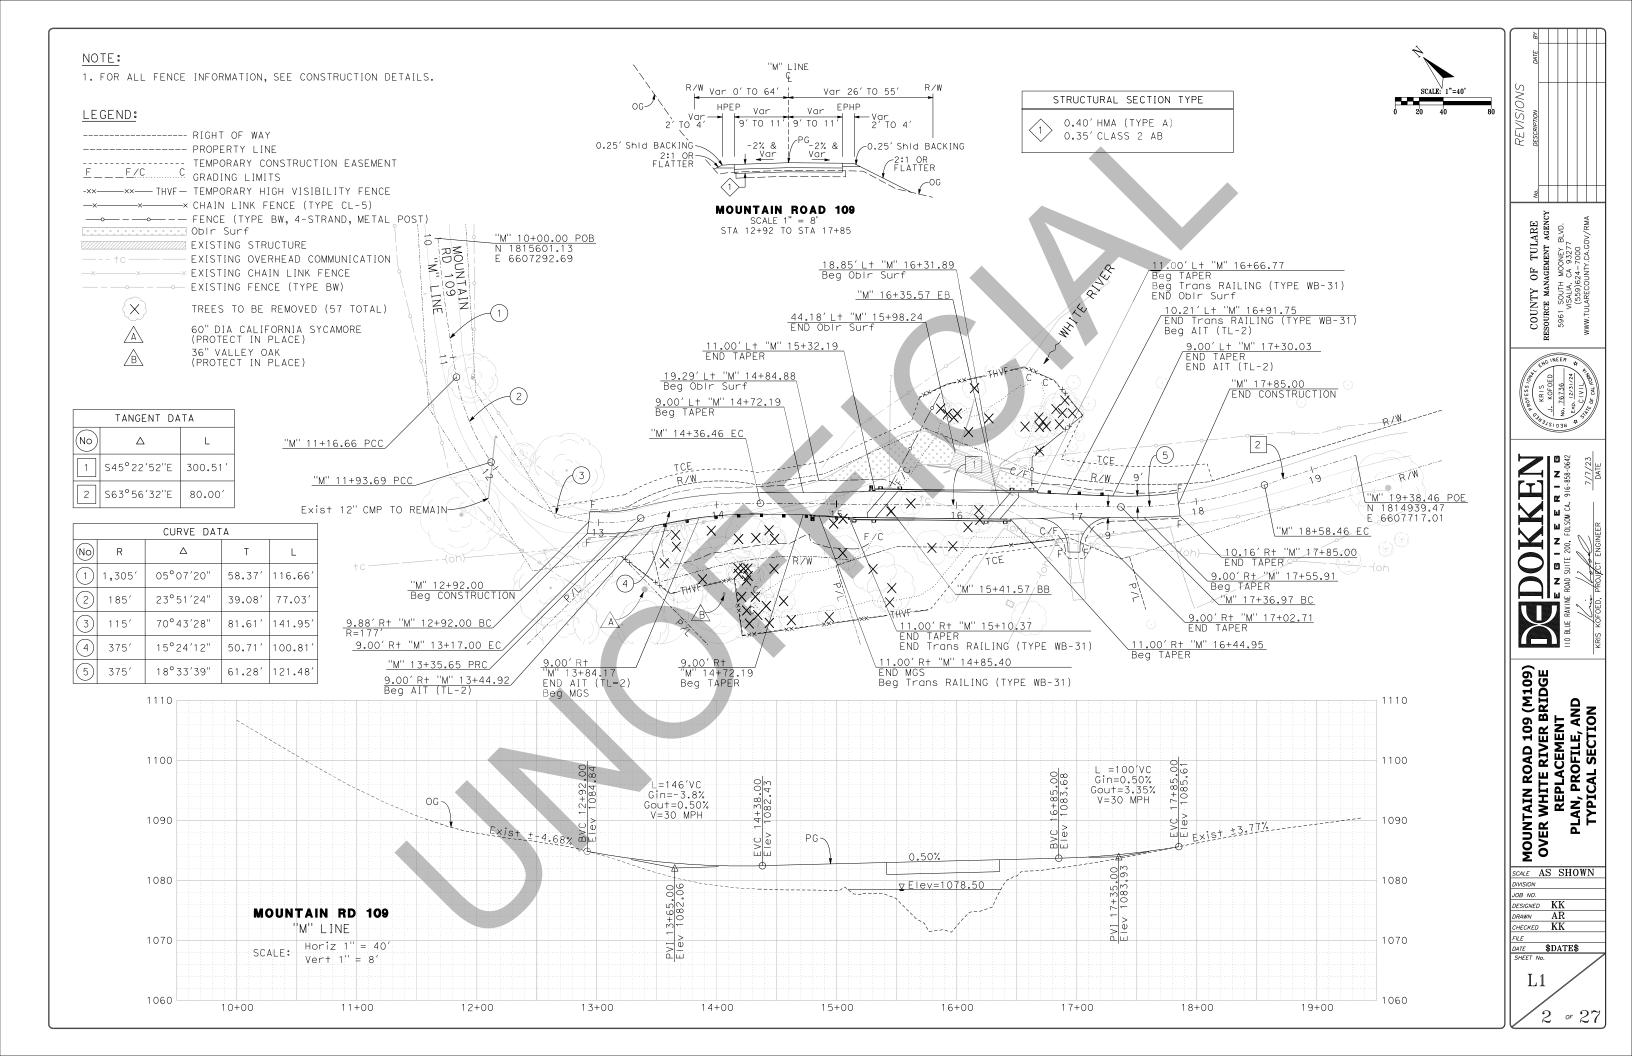

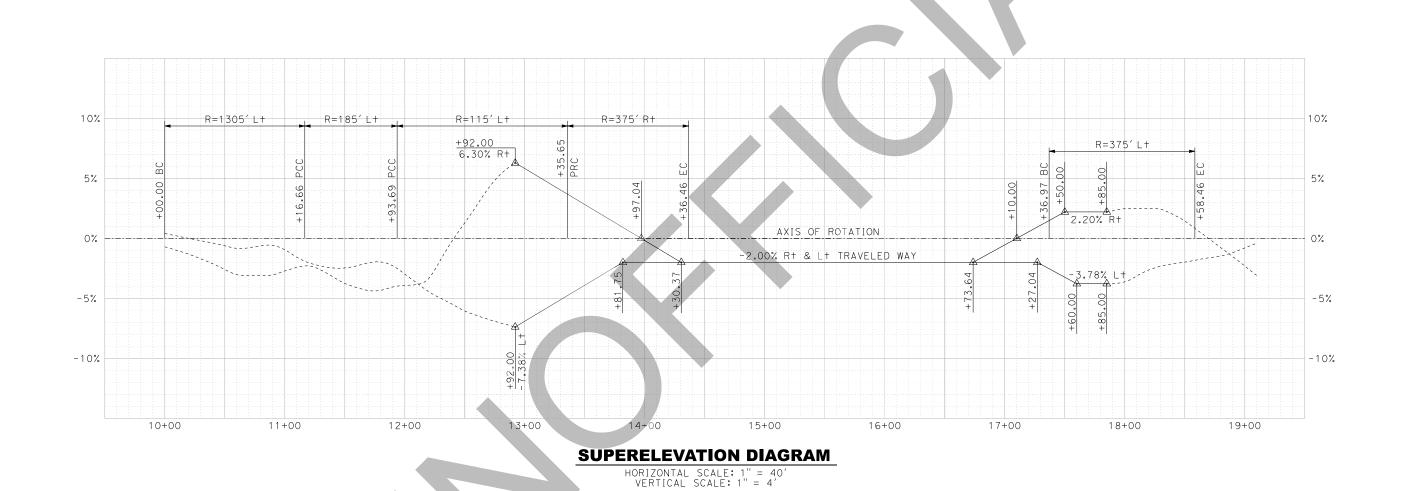

MOUNTAIN ROAD 109 (M109) OVER WHITE RIVER BRIDGE REPLACEMENT

SCALE AS SHOWN DIVISION

JOB NO.

DESIGNED KK


DRAWN AR


CHECKED KK


S1


FILE
DATE \$DATE\$
SHEET No.


SUPERELEVATION DIAGRAM

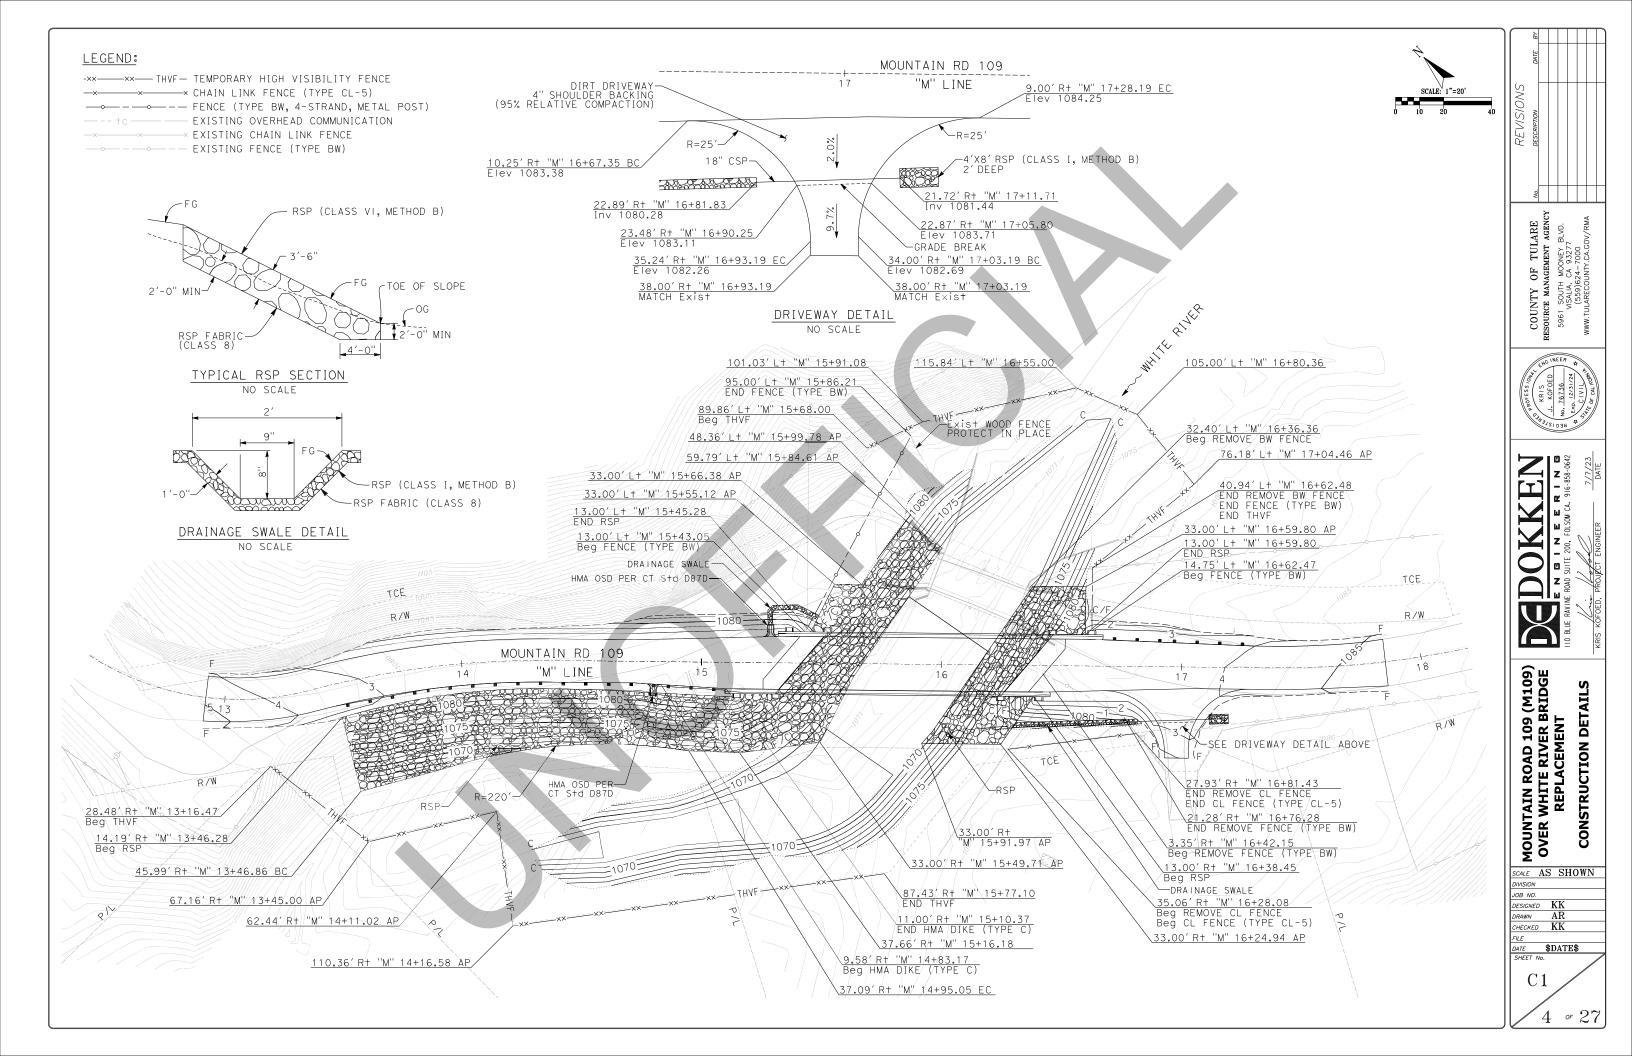


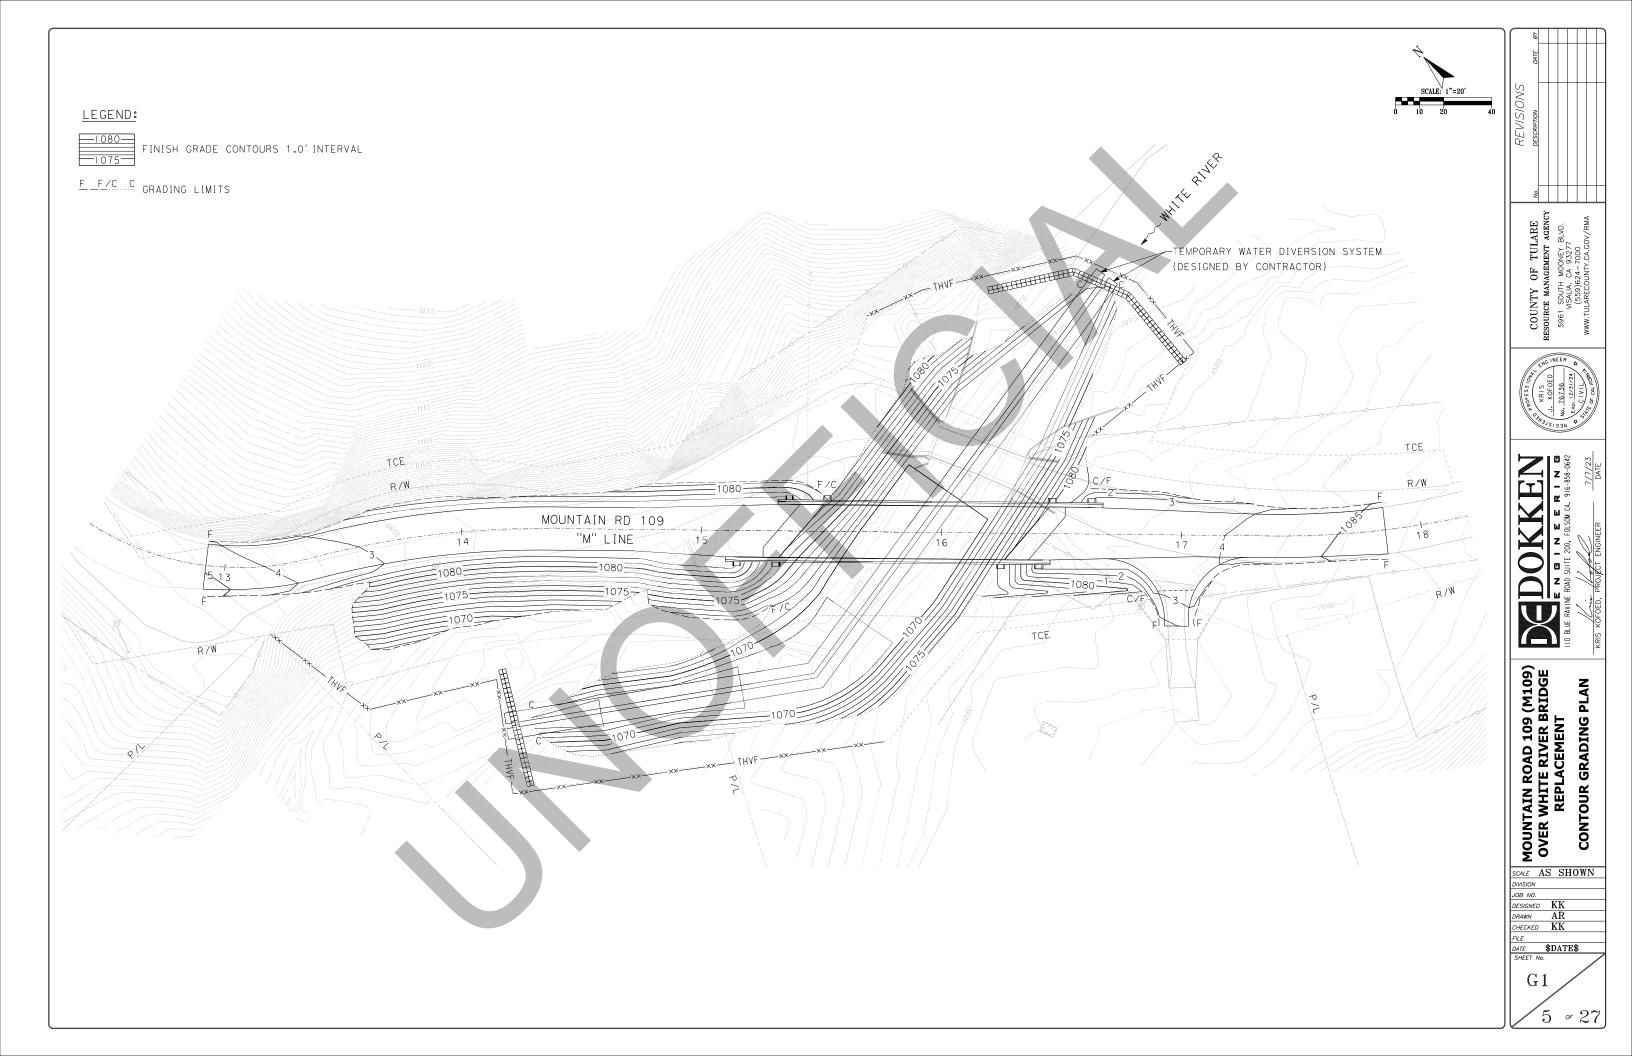


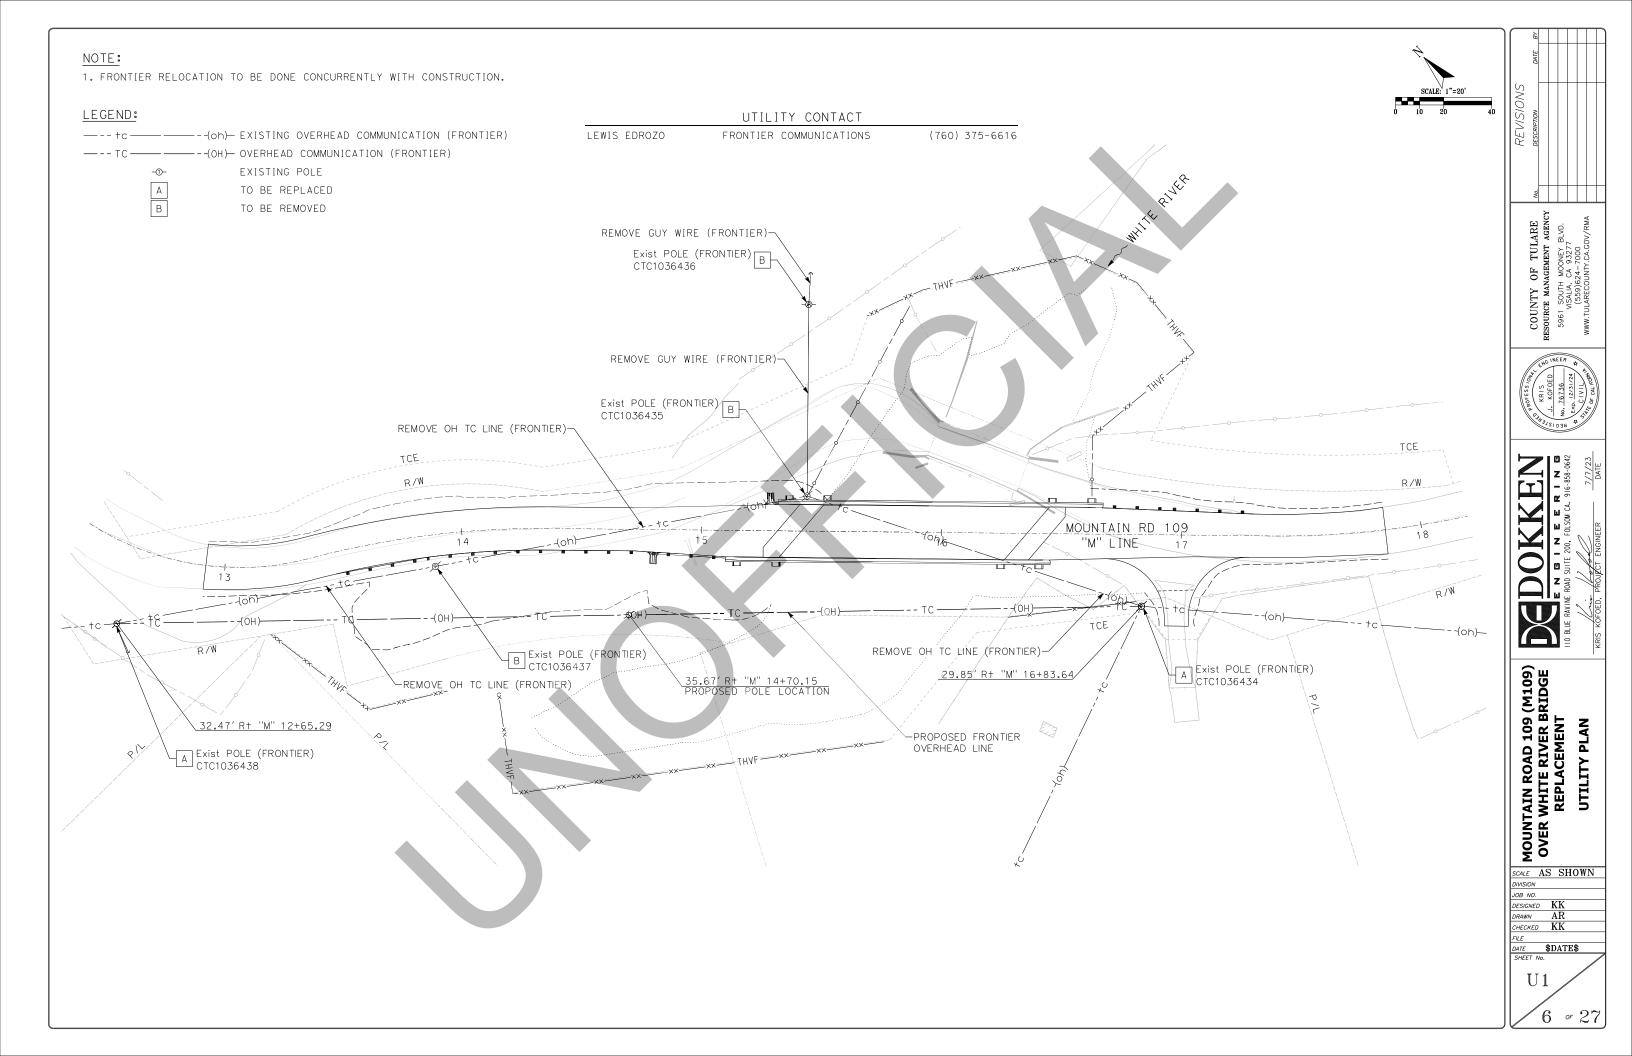


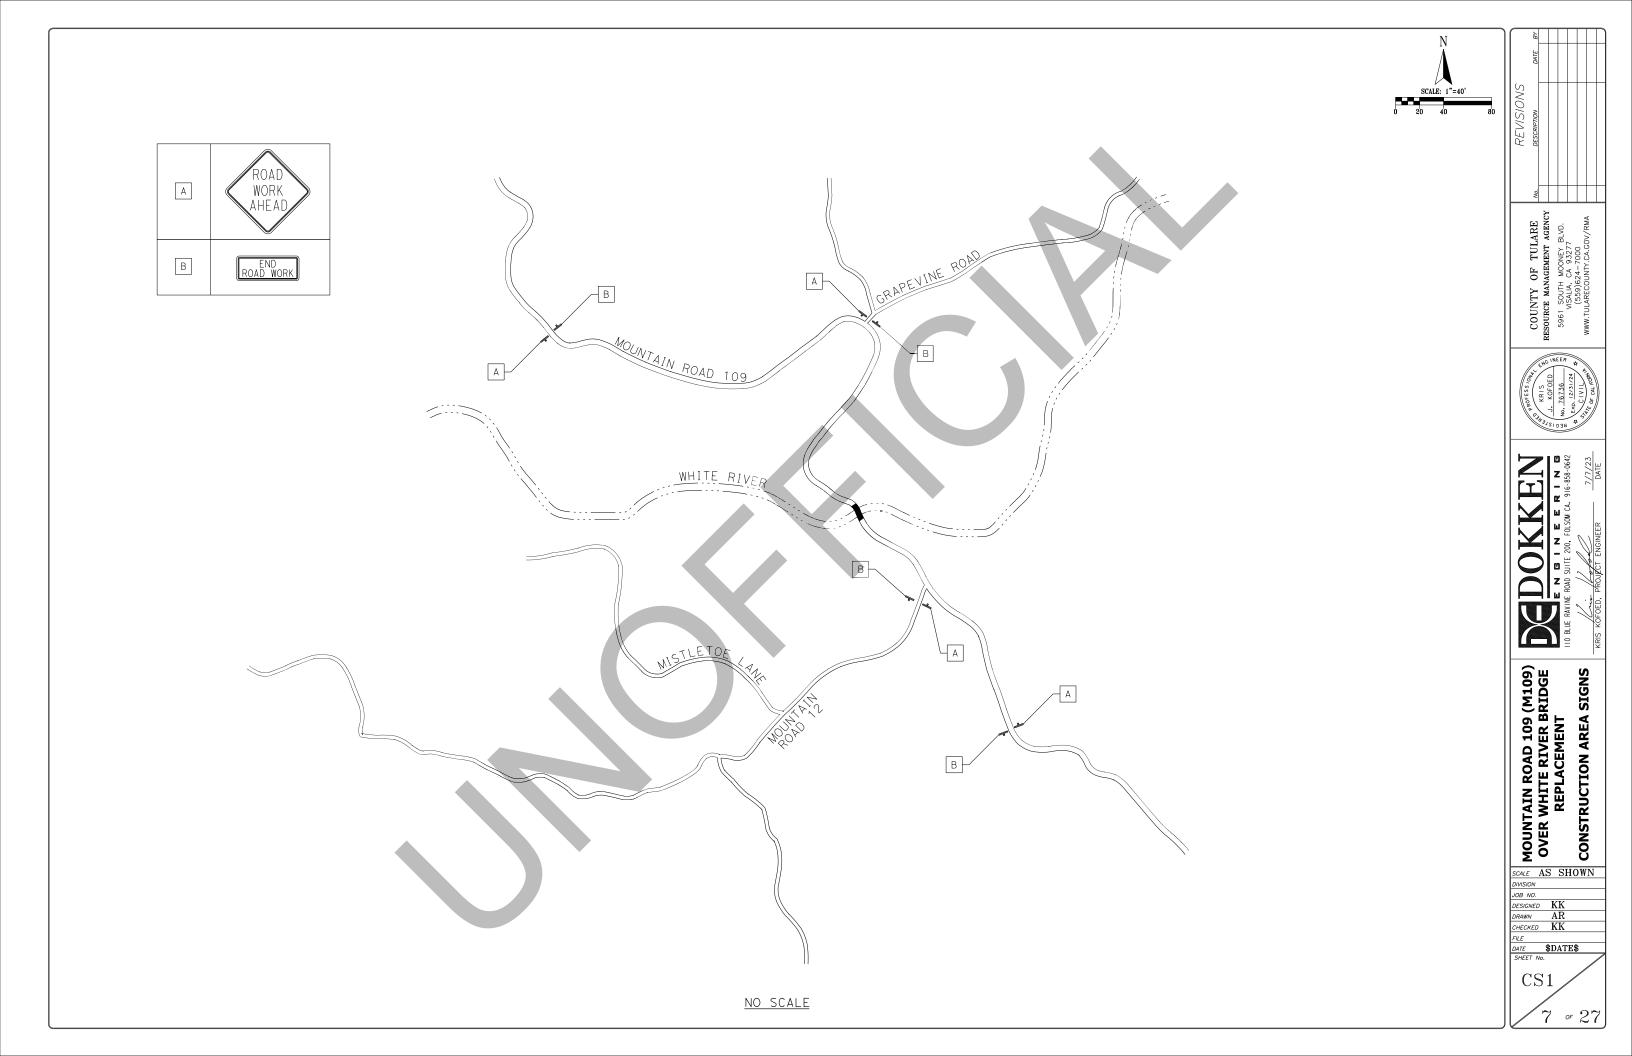


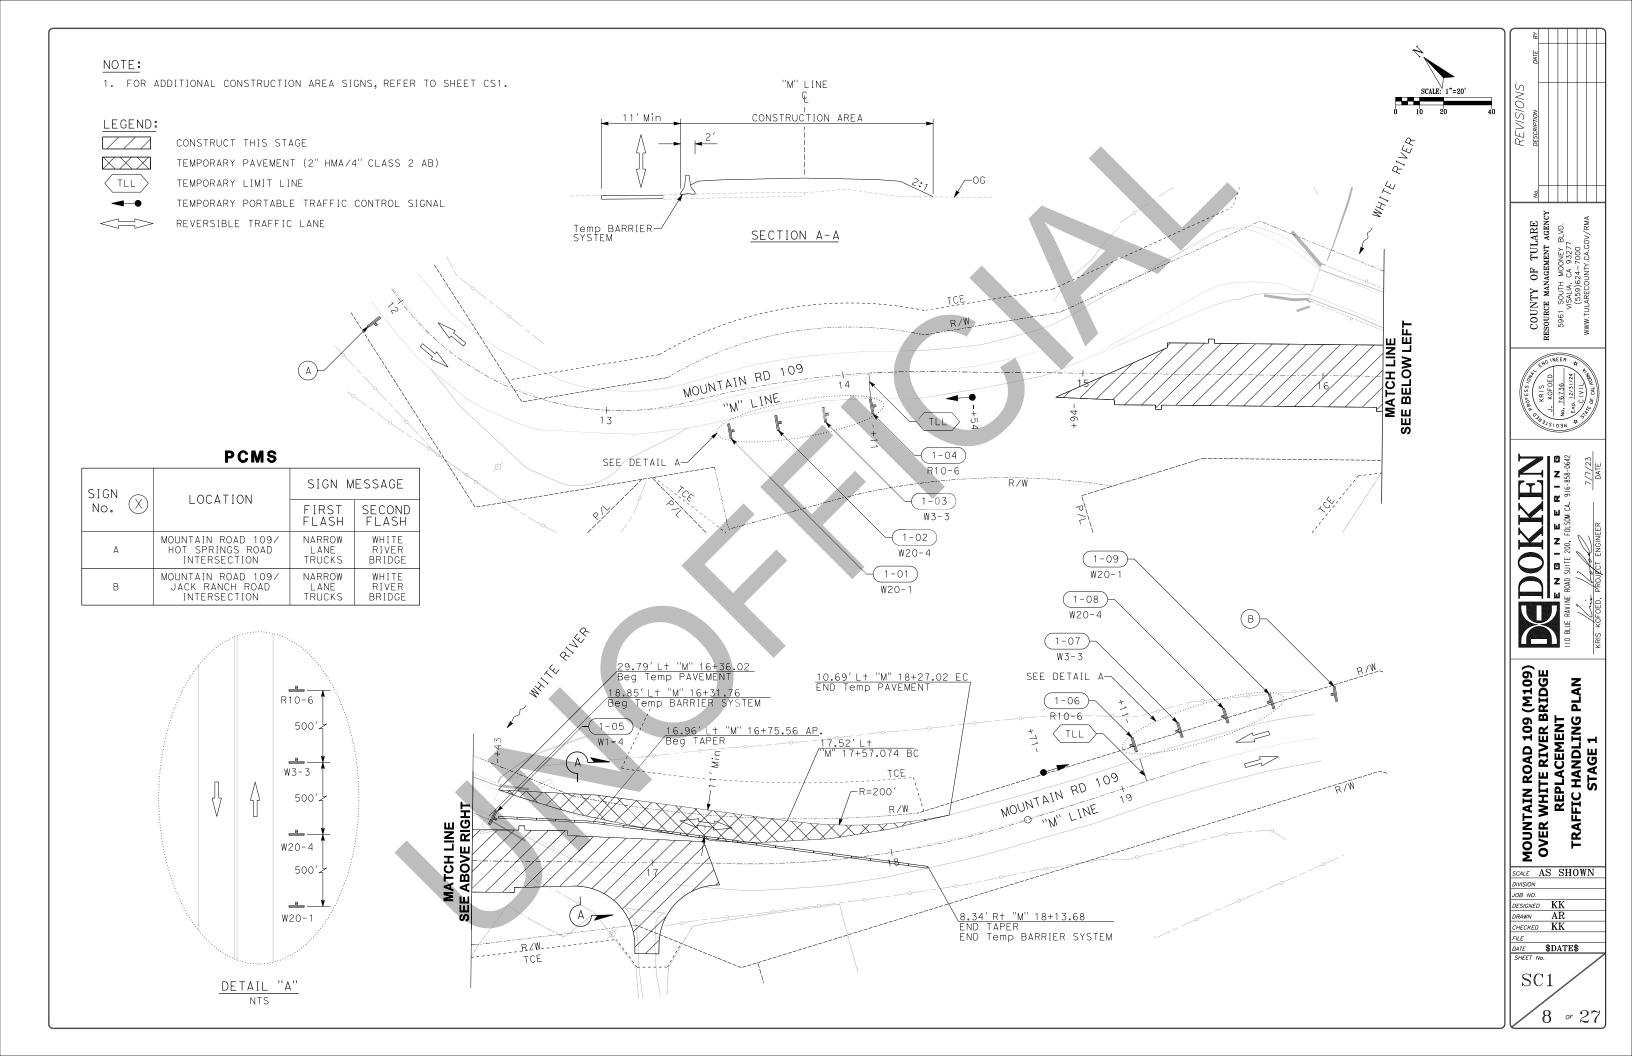

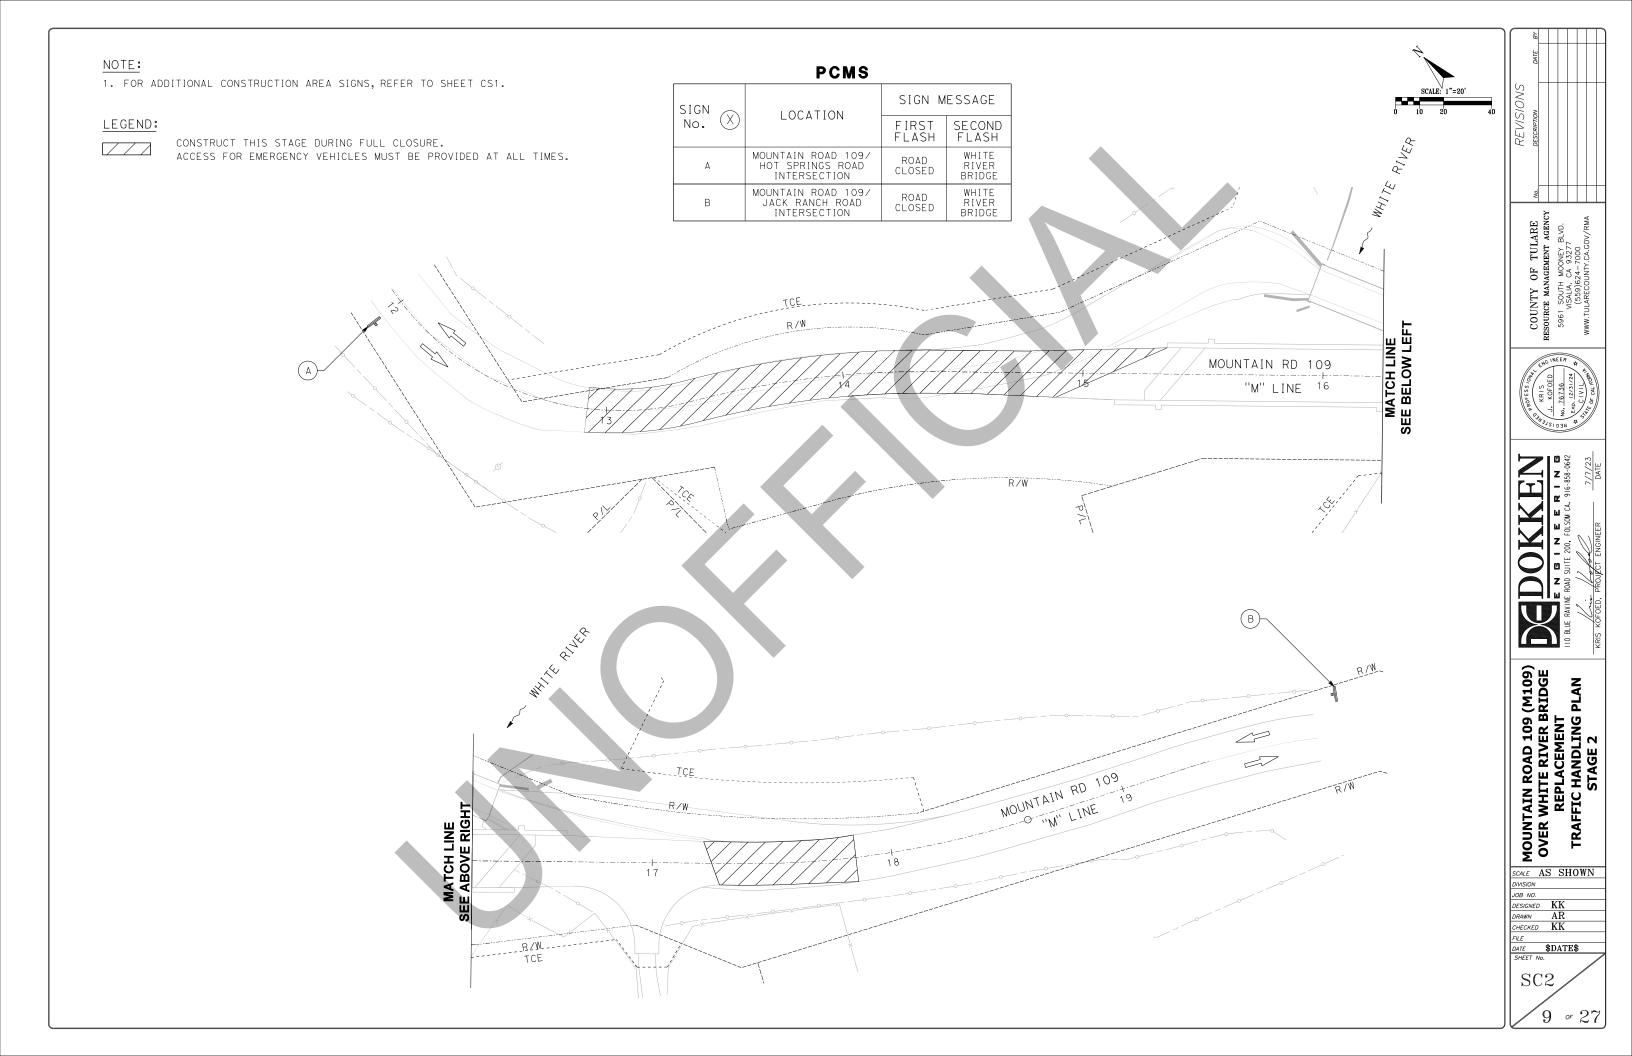

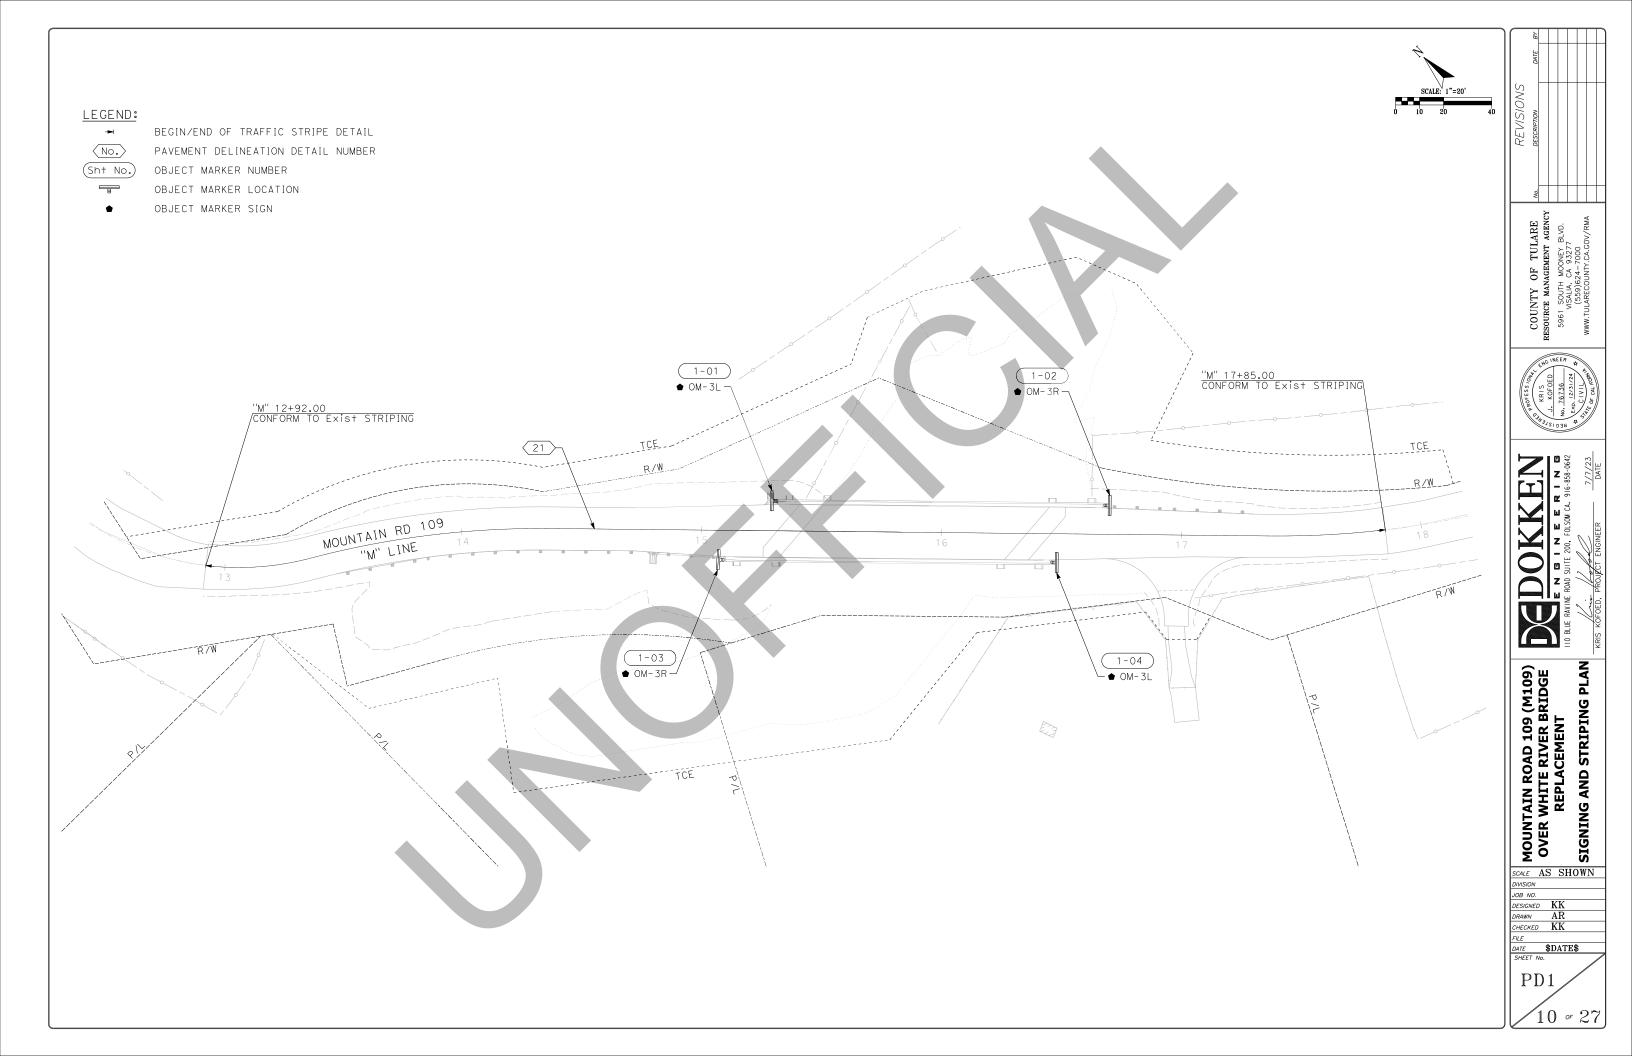

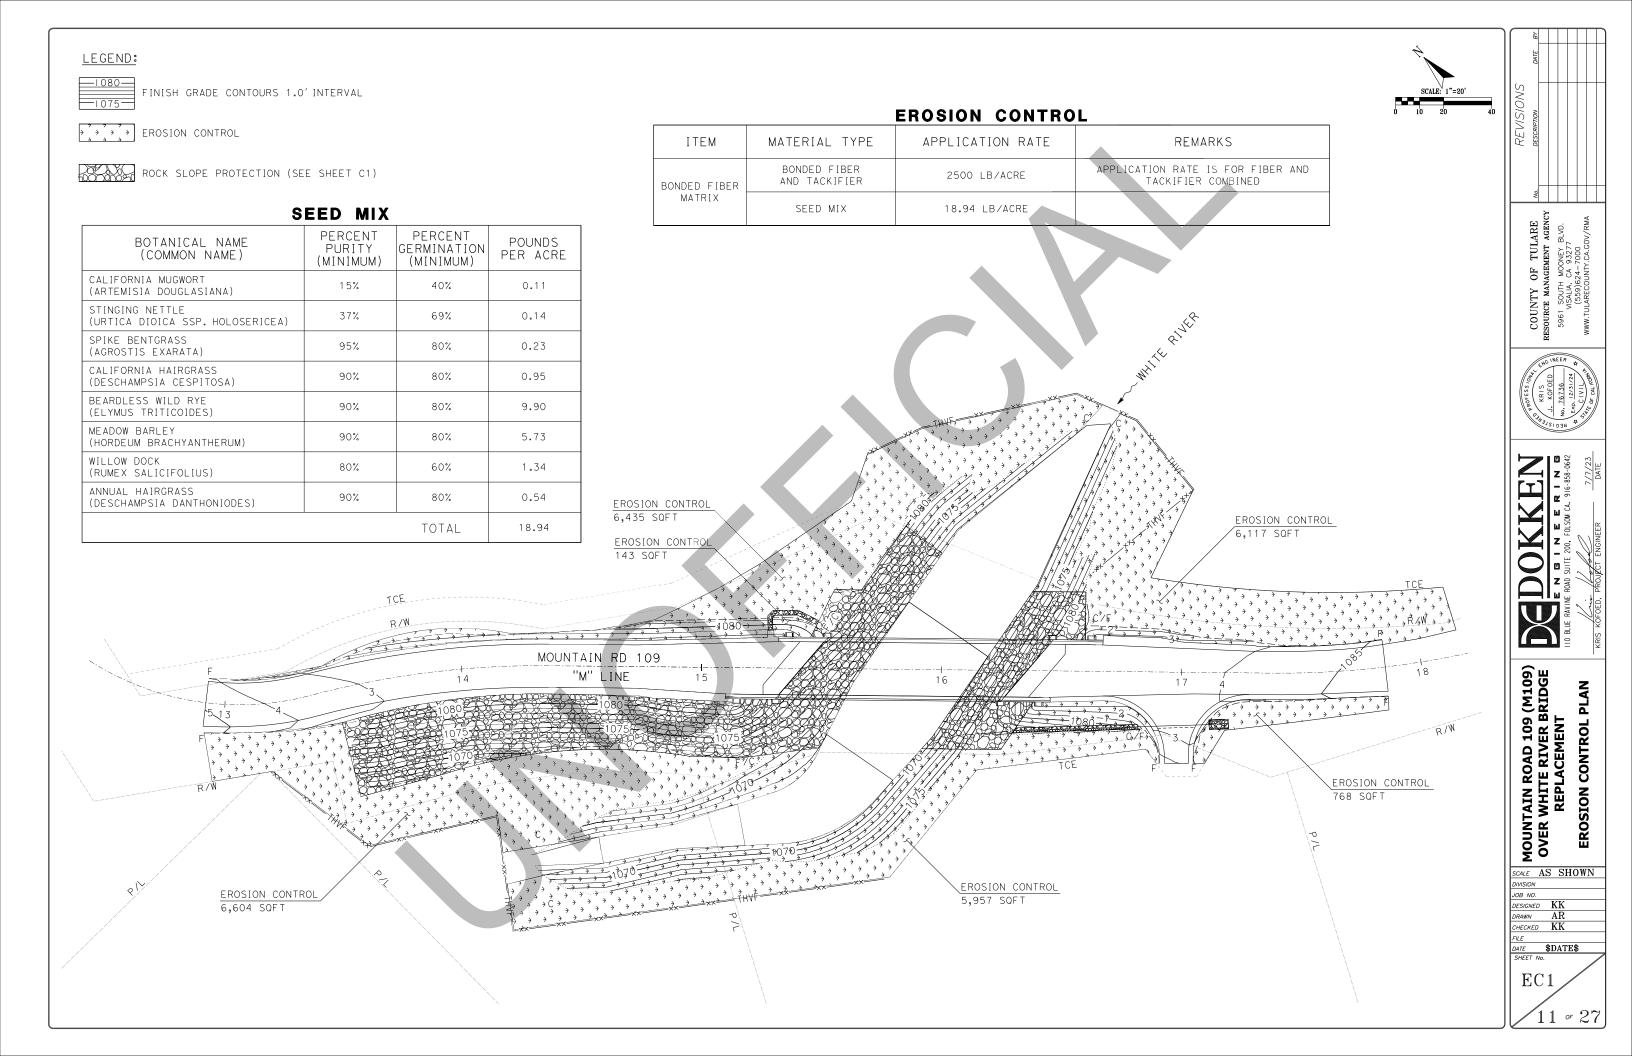

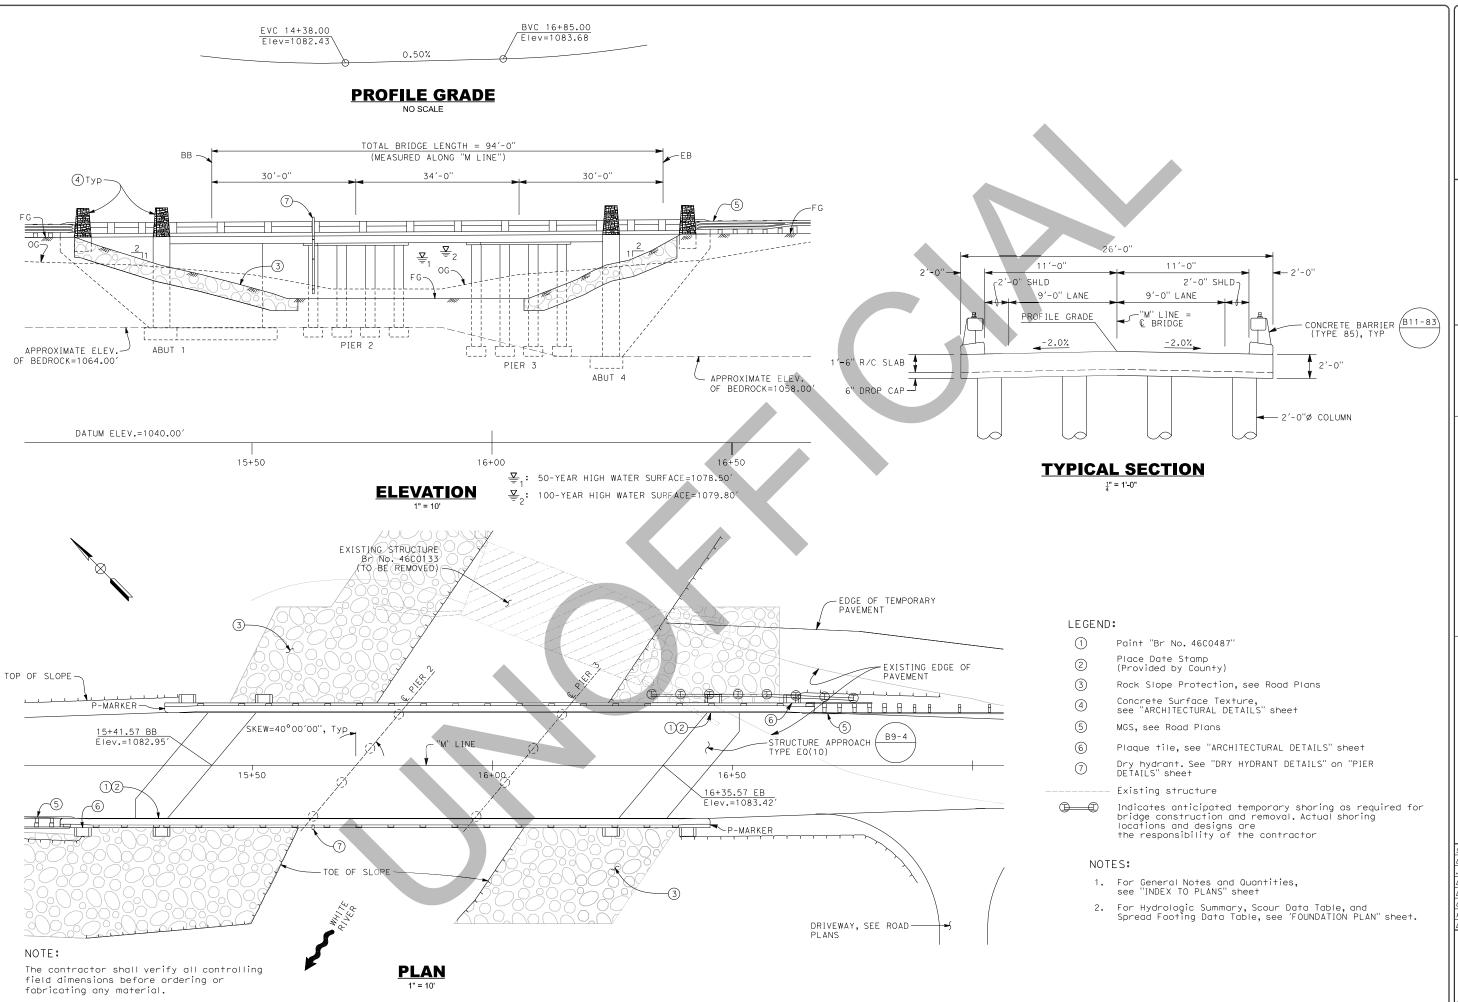

Me DESCRIPTION DATE BY

COUNTY OF TULARE
SSOURCE MANAGEMENT AGENCY
5961 SOUTH MOONEY BLVD.
VISALIA, CA 93277
(\$559)62-7000
WWW.TULARCCOLNIY.CA.GOV/RWA

A POPESS OF THE PROPERS OF THE PROPE

SOM CA. 916-858-0642

IIO BLUE RAVINE ROAD SUITE 200, FOLSOM, CA. A.

MOUNTAIN ROAD 109
OVER WHITE RIVER
BRIDGE

CALE	AS SHOWN
IVISION	STRUCTURES
0B NO.	#2599
ESIGNED	JN
RAWN	MD
HECKED	TP
ILE	
ATE	7/7/23
SHEET N).

S1 / 12 or 2

INDEX TO PLANS

SHEET NO. TITLE GENERAL PLAN S2 S3 INDEX TO PLANS STAGED CONSTRUCTION DECK CONTOURS FOUNDATION PLAN S6 ABUTMENT LAYOUT ABUTMENT DETAILS S7 PIER LAYOUT S9 PIER DETAILS SLAB REINFORCEMENT DETAILS No. 1 SLAB REINFORCEMENT DETAILS No. 2 S11 ARCHITECTURAL TREATMENT DETAILS LOG OF TEST BORINGS NO. 1 S13 S14 LOG OF TEST BORINGS NO. 2 S15 LOG OF TEST BORINGS NO. 3 LOG OF TEST BORINGS NO. 4

GENERAL NOTES LOAD AND RESISTANCE FACTOR DESIGN

DESIGN:	AASHTO LRFD Bridge Design Specifications, 8th Edition
	with California Amendments, preface dated November 2019

SEISMIC DESIGN: CALTRANS SEISMIC DESIGN CRITERIA (SDC)

Version 2.0, April 2019 with October 2019 Revisions

ADDED DEAD LOAD: Includes 35 psf for future wearing surface

LIVE LOAD: HL93 Design Load


P15 Permit Load

SEISMIC LOAD: Soil profile : V_{S30} = 2493 ft/s

Moment Magnitude : 6.16

Peak Ground Acceleration = 0.23g


5% Damping

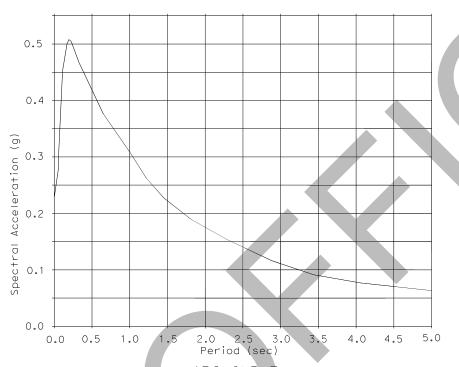

ARS CURVE


REINFORCED CONCRETE: = 60 ksi

3.6 ksi

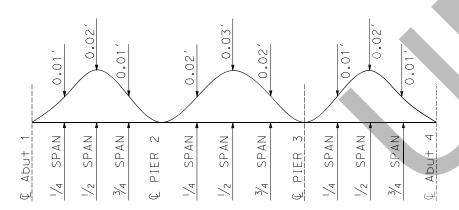

CAMBER DIAGRAM

NO SCALE

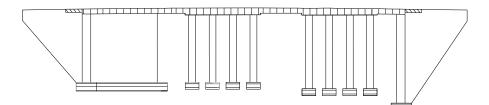

CONCRETE STRENGTH AND TYPE LIMITS




QUANTITIES		
ITEM	UNIT	QUANTITY
BRIDGE REMOVAL	LS	1
STRUCTURE EXCAVATION (ROCK)*	CY	80
STRUCTURE EXCAVATION (TYPE D)*	CY	570
STRUCTURE BACKFILL (BRIDGE)	CY	450
TEMPORARY SHORING	LS	1
STRUCTURAL CONCRETE, BRIDGE FOOTING	CY	35
STRUCTURAL CONCRETE, BRIDGE	CY	230
STRUCTURAL CONCRETE, BRIDGE (POLYMER FIBER)	CY	140
STRUCTURAL CONCRETE, APPROACH SLAB (TYPE EQ)	CY	22
CONCRETE SURFACE TEXTURE (DRY STACK)	SQFT	420
DRILL AND BOND DOWEL	LF	120
JOINT SEAL (MR 1/2")	LF	63
BAR REINFORCING STEEL (BRIDGE)	LB	90000
BAR REINFORCING STEEL (GALVANIZED)	LB	2000
PREPARE AND STAIN CONCRETE	SQFT	500
CONCRETE BARRIER (TYPE 85)	LF	271
MISCELLANEOUS METAL (DRY HYDRANT)	LB	190
WORK AREA MONITORING (BRIDGE)	LS	1

^{*}FOR PAY LIMITS OF EXCAVATION, SEE "DECK CONTOURS" SHEET

STANDARD PLANS DATED 2022

A3A A3B A3C A10A	Abbreviati Abbreviati	ions (Sheet 1 of 3) ions (Sheet 1 of 3) ions (Sheet 1 of 3) Lines and Symbols (Sheet 1 of 5)	
A10E	<i>J</i>	Lines and Symbols (Sheet 1 of 5)	
A100		Lines and Symbols (Sheet 1 of 5)	
A10E		Lines and Symbols (Sheet 1 of 5)	
A10E		Lines and Symbols (Sheet 1 of 5)	
RSP A10F		Soil (Sheet 1 of 2)	
RSP A100		Soil (Sheet 1 of 2)	
		Payment for Excavation and Back	
RSP A77L		uardrail System - Connections to	
DCD 4771		and Walls	
RSP A77L		Jardrail System - Connections to and Walls	
B0-1			
BO-3	J		
BO-5			
	3 Bridge Det		
B6-2		s (Maximum Movement Rating = 2"	')
B9-4	Structure	Approach Type EQ (10)	
B9-5	Structure	Approach - Slab Details	
B9-6		Approach - Drainage Details	
B11-		Barrier Type 85 (Sheet 1 of 3)	
B11-		Barrier Type 85 (Sheet 1 of 3)	
B11-	-85 Concrete E	Barrier Type 85 (Sheet 1 of 3)	

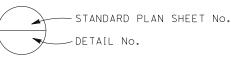

COUNTY OF TULARE RESOURCE MANAGEMENT AGENCY






MOUNTAIN ROAD 109 OVER WHITE RIVER BRIDGE **INDEX TO PLANS**

SCALE	AS SHOWN
DIVISION	STRUCTURES
JOB NO.	#2599
DESIGNED	JN
DRAWN	MD
CHECKED	TP
FILE	
DATE	7/7/23
SHEET NO	o. /

S2

13 or 27

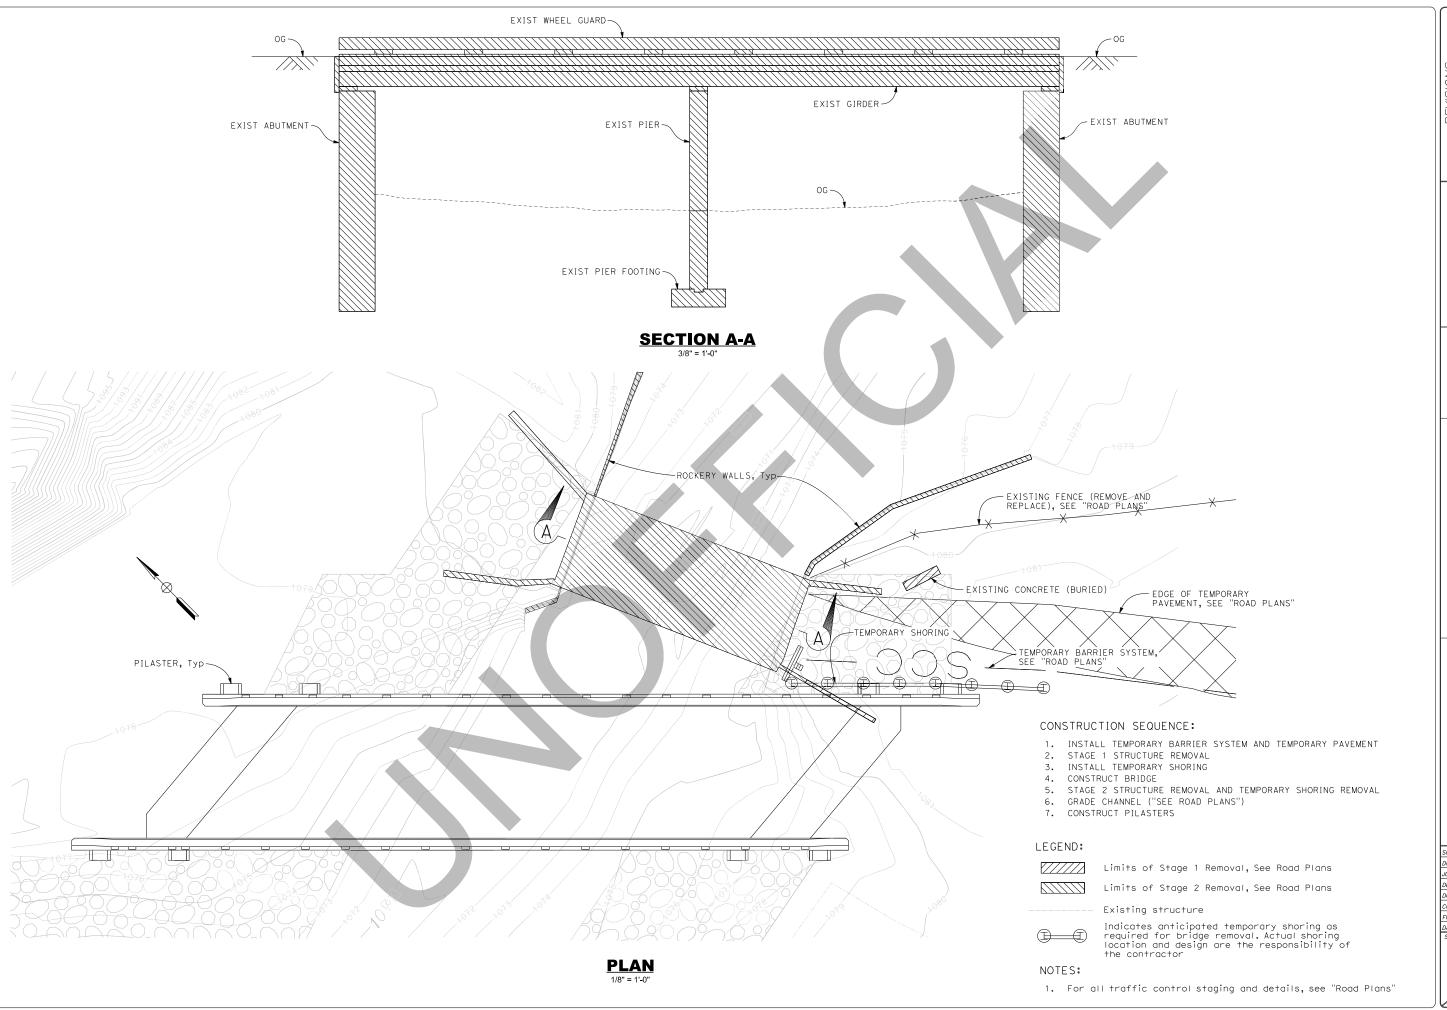




MOUNTAIN ROAD 109 OVER WHITE RIVER BRIDGE STAGED CONSTRUCTION

SCALE AS SHOWN DIVISION STRUCTURES

JOB NO. #2599 JN DESIGNED RAWN MD CHECKED TP 7/7/23 DATE 7 SHEET No.

S3

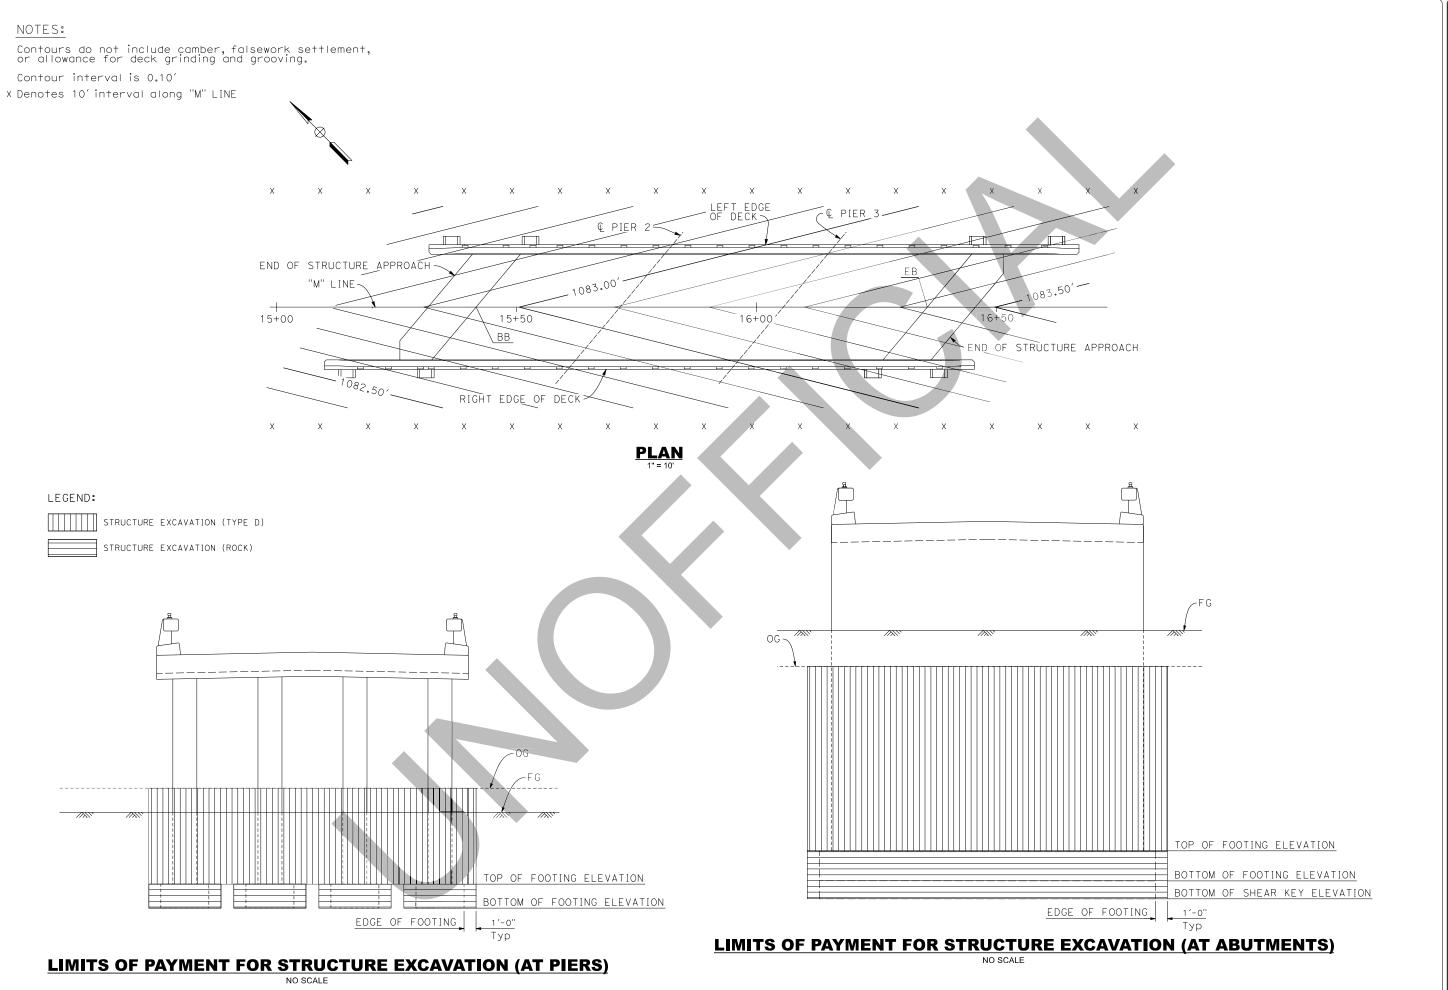

REVISIONS
No. DESCRIPTION DATE

RESOURCE MANAGEMENT AGEN(
5961 SOUTH MOONEY BLVD.
VISALIA, CA 93277
(559)624-7000
WWW.TULARECOUNTY.CA.GOV/RM



SUITE 200, FOLSOW CA. 916-888-0642

I DELUE RAVINE ROAD SUITE 2

MOUNTAIN ROAD 109 OVER WHITE RIVER BRIDGE DECK CONTOURS

SHEET No.


15 or 27

Scour Data Table			
Support Location	Long Term (Deg And Contraction) Scour Elev (ft)	Short Term Scour (Local) Depth (ft)	Total Scour * Elevation (ft)
ABUT 1	1065.60′	4.50′	1061.10′
PIER 2	1065.60′	5.60′	1059.90′
PIER 3	1065.60′	4.60′	1061.00′
ABUT 4	1065.60′	5.90′	1059.70′

Hydraulic / Hydrology Data		
Drainage Area = 57.4 Sq Mi.	DESIGN FLOOD	BASE FLOOD
Frequency	50 YEAR	100 YEAR
Discharge	3570 CFS	4650 CFS
Proposed Water Surface Elevation at Face of Bridge	1078.5	1079.8

Spread Footing Data Table			
	Load and Resistance Factor Design (LRFD)		
Support Location	Service Permissible Net Contact Stress (Settlement) (ksf)	Strength/Construction Factored Gross Nominal Bearing Resistance • 0.45 (ksf)	Extreme Event Factored Gross Nominal Bearing Resistance Φ= 1.00 (ksf)
ABUT 1	35.3	222.4	N/A
PIER 2	52.7	162.6	361.3
PIER 3	52.7	162.6	361.3
ABUT 4	37.1	249.5	N/A

* Top of footing elevations are to be placed below bedrock as determined by engineer. Bedrock must be non-scourable. Footing elevations may be adjusted by the engineer based on field conditions encountered during construction.

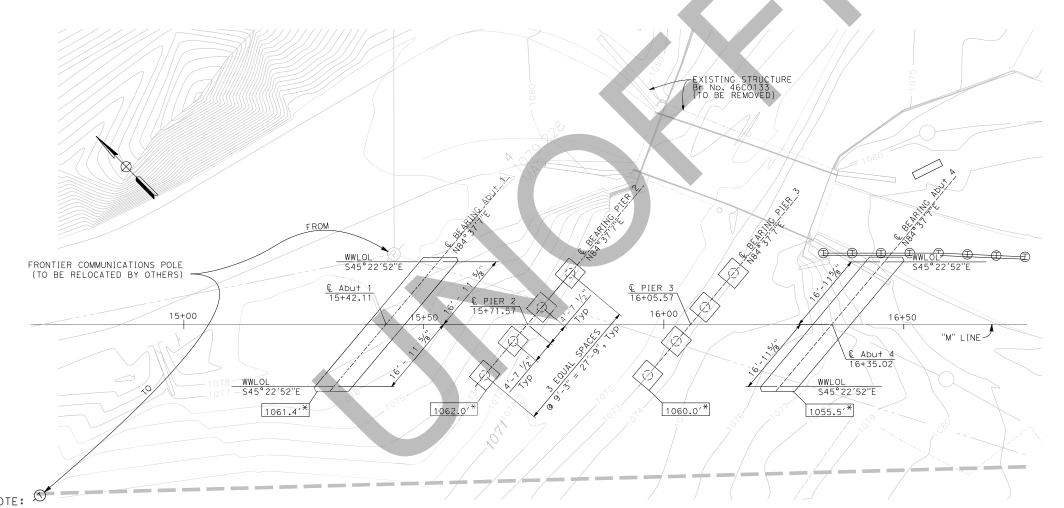

LEGEND:

XXXX.XX' Indicates bottom of footing elevation

NOTES:

Indicates anticipated temporary shoring as required for bridge removal. Actual shoring locations and designs are the responsibility of the contractor

No. DESCRIPTION DATE

SOURCE MANAGEMENT AGEN(
5961 SOUTH MOONEY BLVD.
VISALIA, CA 93277
(559)624-7000
WW.TULARECOUNTY.CA.GOV/RM



MOUNTAIN ROAD 109 OVER WHITE RIVER BRIDGE FOUNDATION PLAN


SCALE	AS SHOWN
DIVISION	STRUCTURES
JOB NO.	#2599
DESIGNED	JN
DRAWN	MD
CHECKED	TP
FILE	
DATE	7/7/23

SHEET No.

16 of 27

PLAN1" = 10'

The contractor shall verify all controlling field dimensions before ordering or fabricating any material.

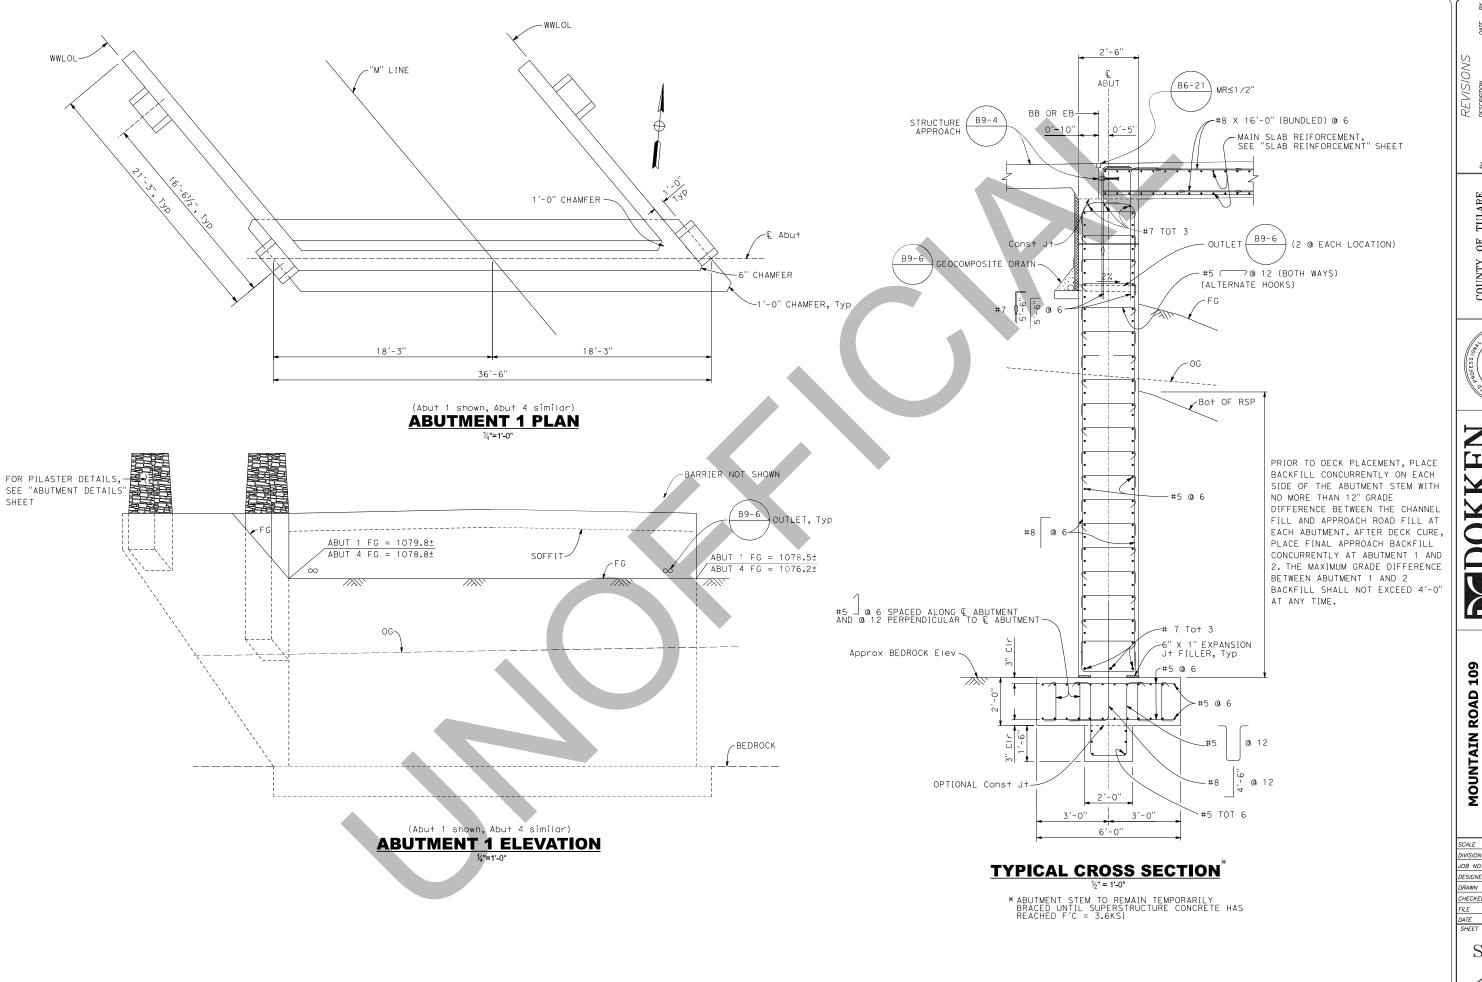

REVISIONS
DESCRIPTION
DATE

SOURCE MANAGEMENT AGEN
5961 SOUTH MOONEY BLVD.
VISALIA, CA 93277
(559)624-7000




MENDOKKEN BENING BANNE ROAD SUITE 200, FOLSOM CA. 916-856-0642


MOUNTAIN ROAD 109 OVER WHITE RIVER BRIDGE ABUTMENT LAYOUT

SCALE	AS SHOWN
DIVISION	STRUCTURES
JOB NO.	#2599
DESIGNED	JN
DRAWN	MD
CHECKED	TP
FILE	
DATE	7/7/23
SHEET NO	o. /
~	<u>, </u>

S6

 $17 \circ 2$

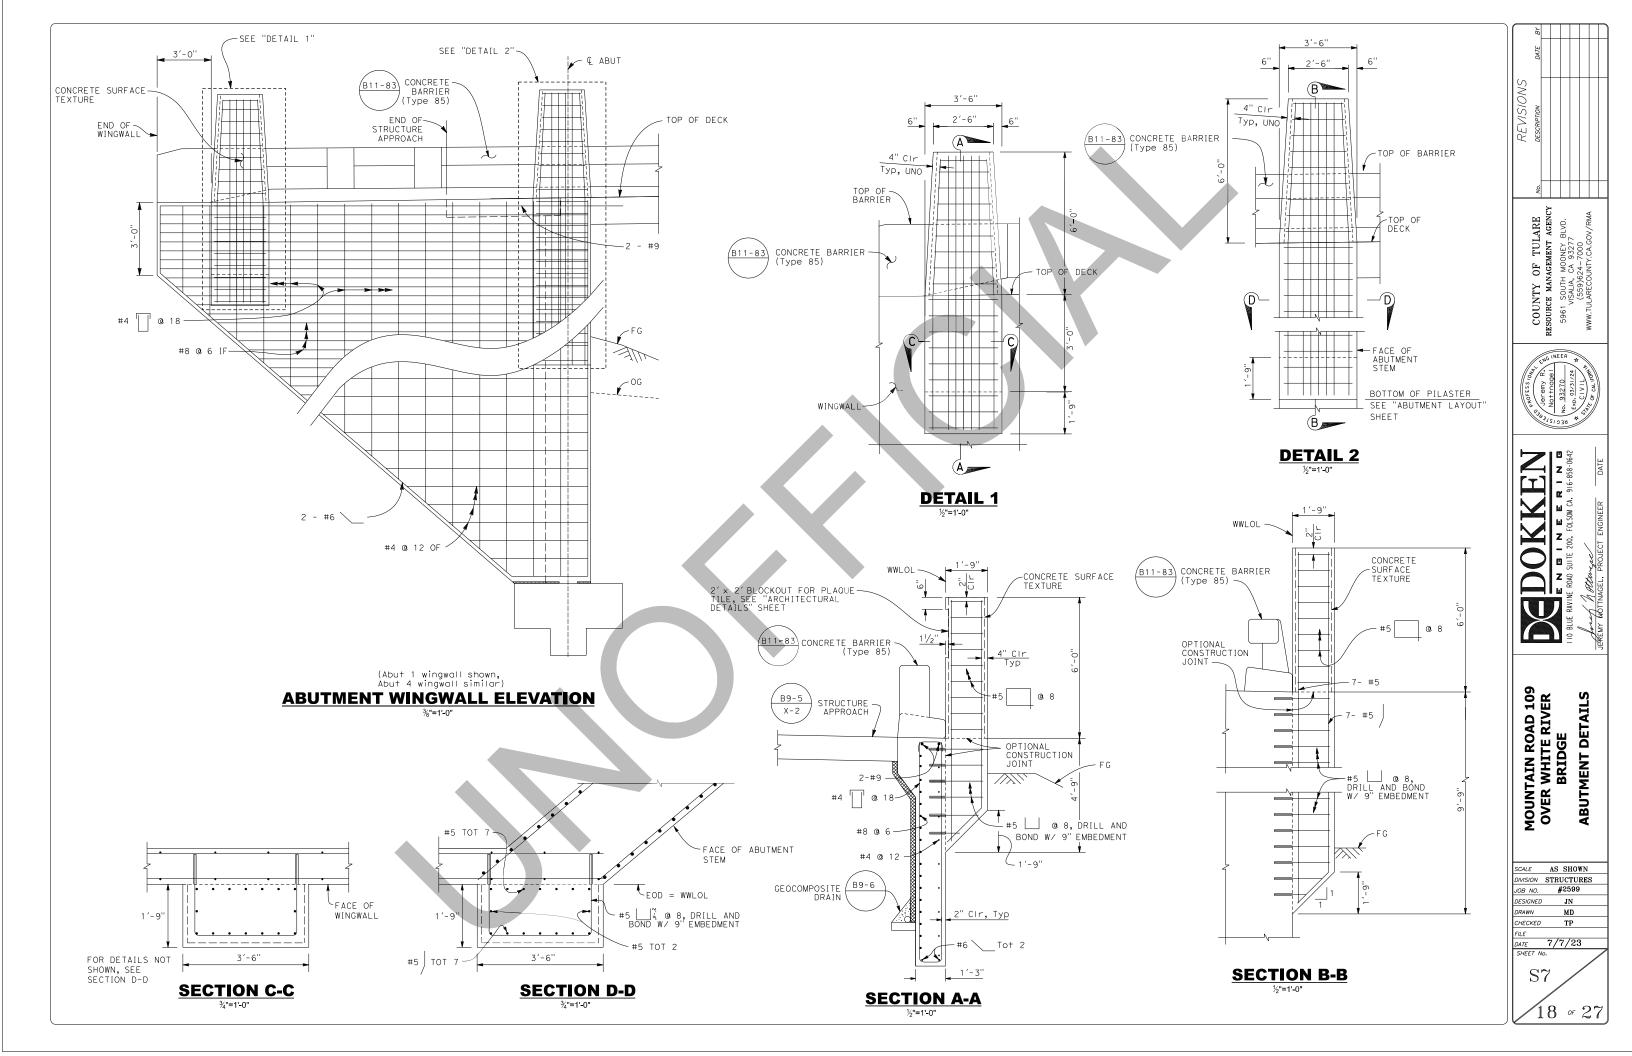

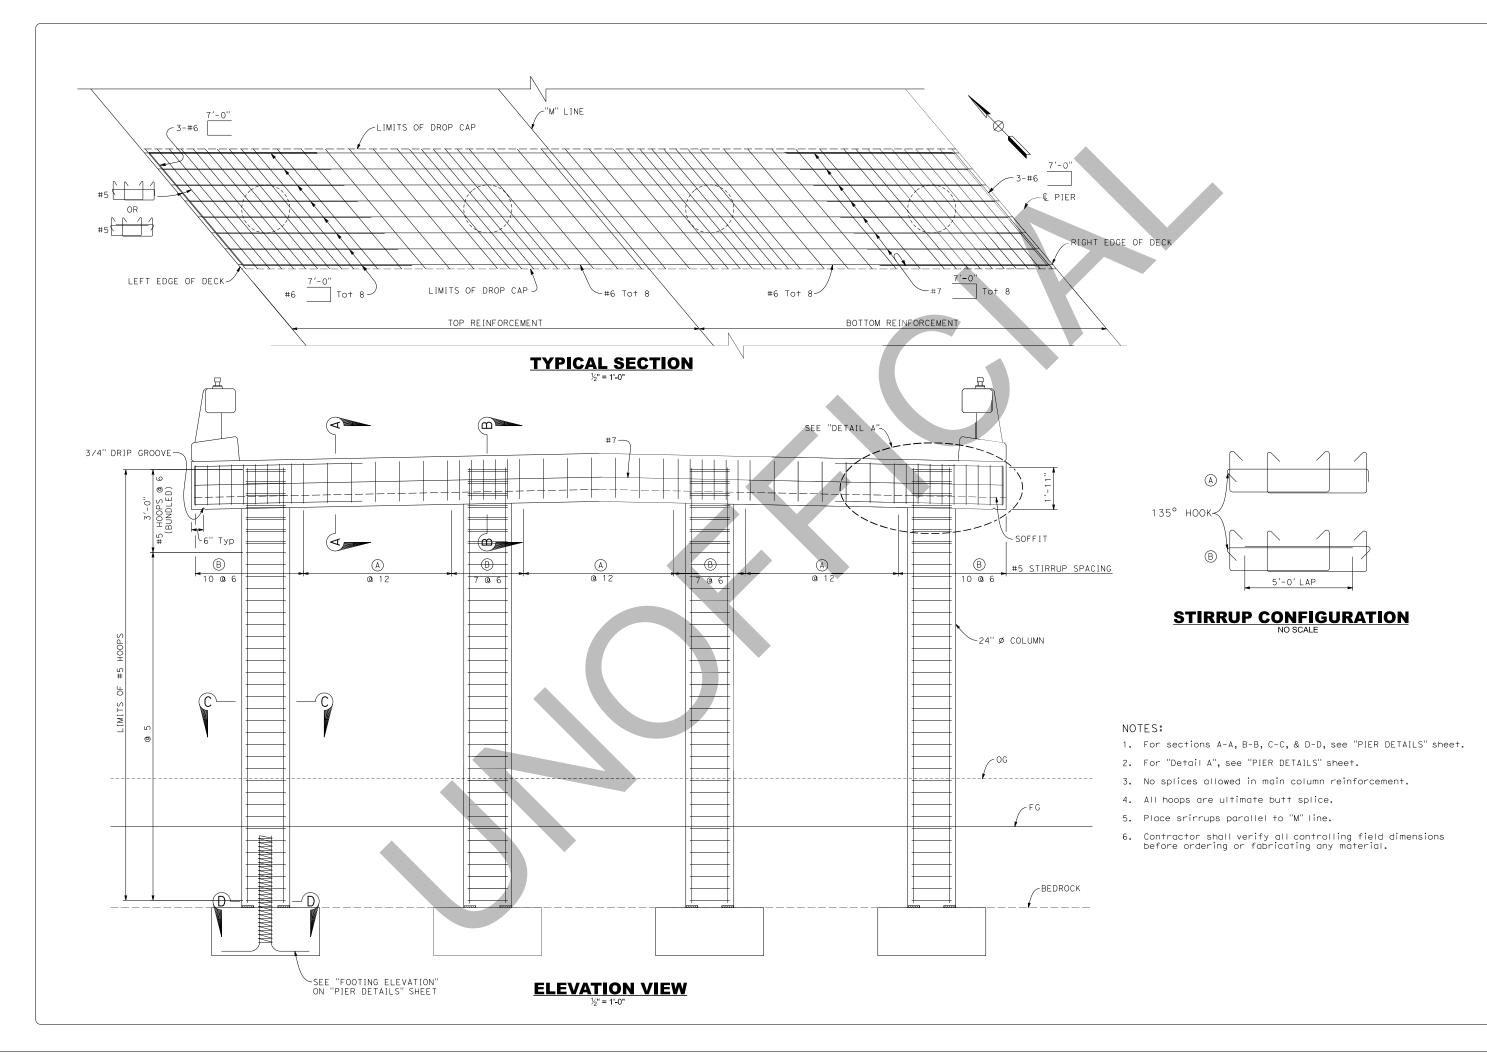

COUNTY OF TULARE
RESOURCE MANAGEMENT AGENCY
5961 SOUTH MOONEY BLVD.
VISALIA, CA 932.7
VISALIA, CA 932.7
VISALIA, CA 932.7
WWW.TULARECOUNTY.CA.GOV.RNA





DOKKEN

MOUNTAIN ROAD 109 OVER WHITE RIVER BRIDGE PIER LAYOUT

SCALE	AS SHOWN
DIVISION	STRUCTURES
JOB NO.	#2599
DESIGNED	JN
DRAWN	MD
CHECKED	TP
FILE	
DATE	7/7/23
OUICET II	

S8

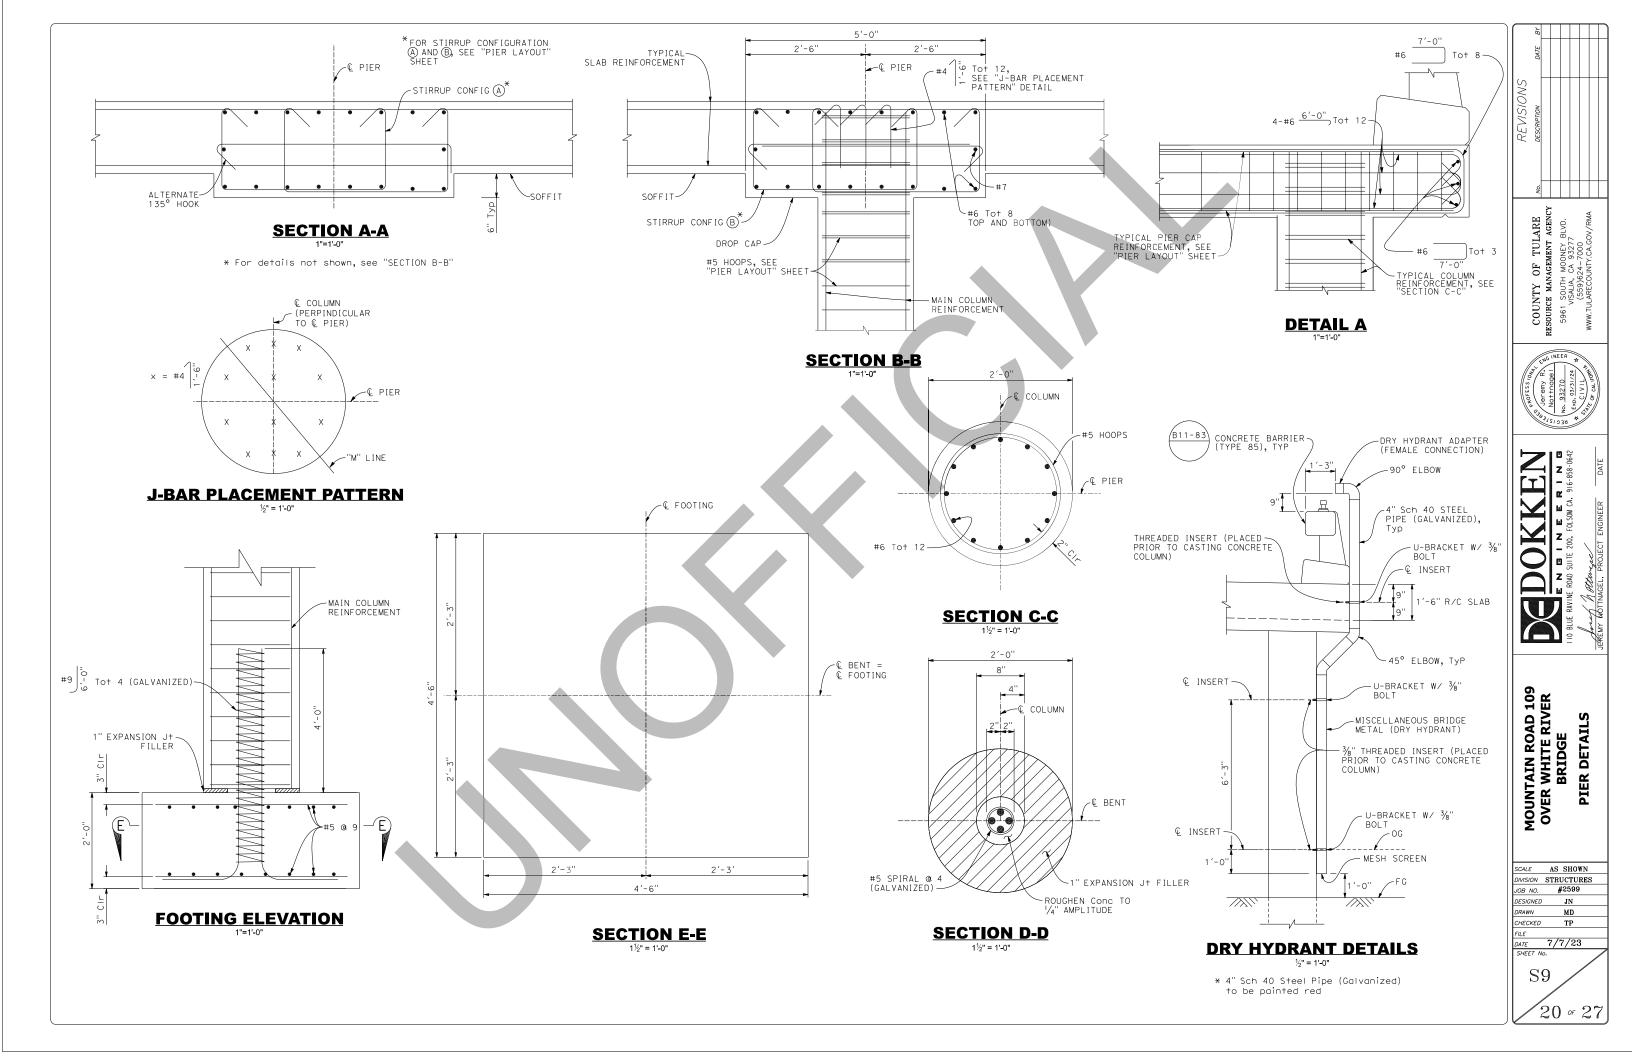

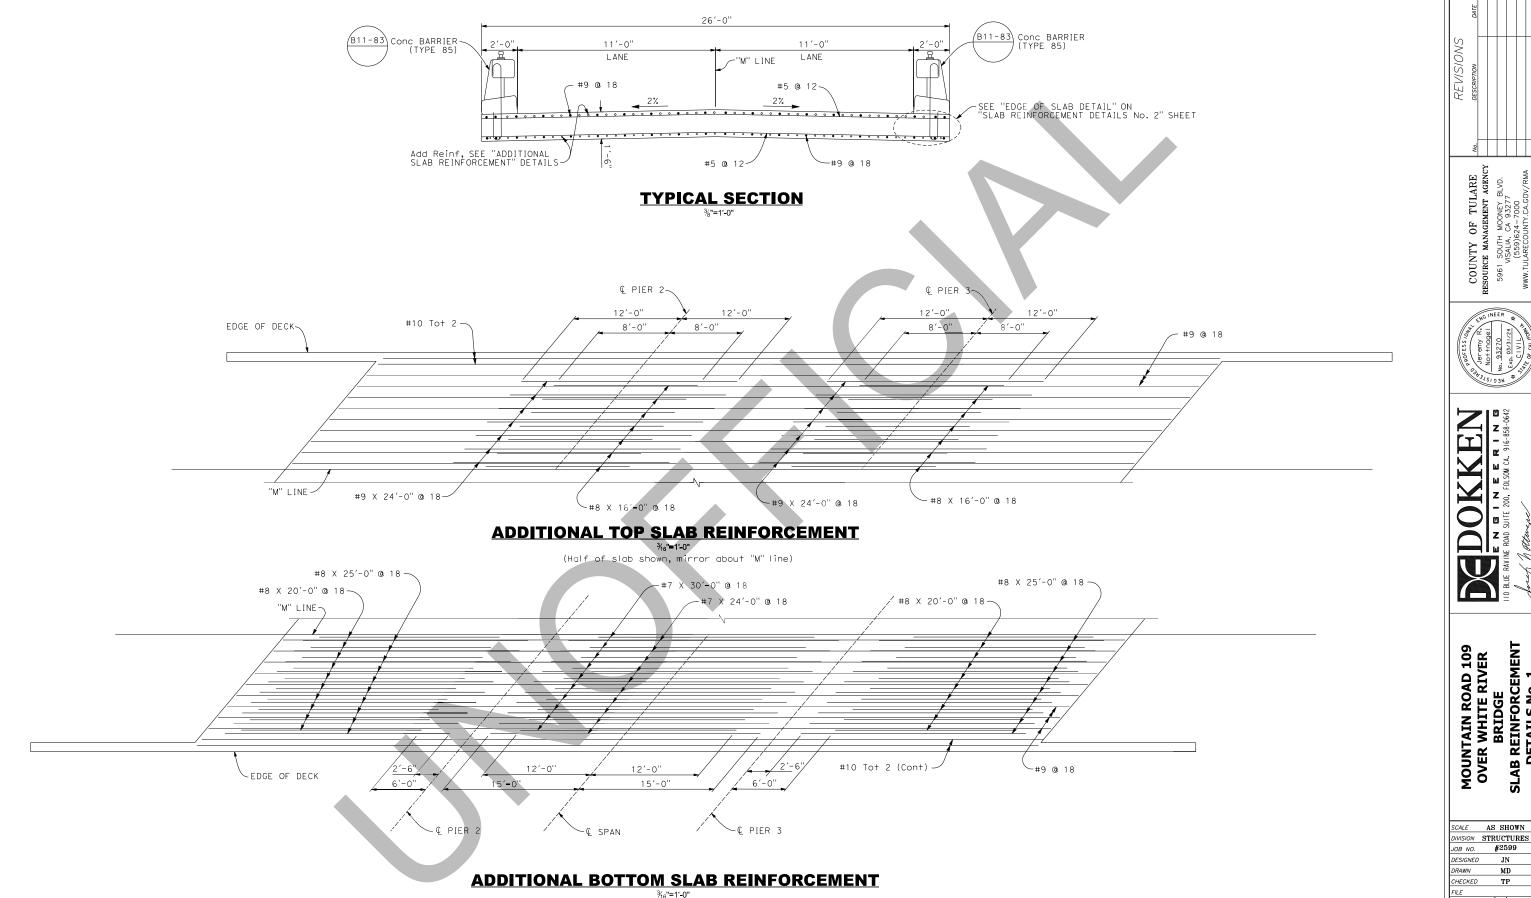


(Half of slab shown, mirror about "M" line)



MOUNTAIN ROAD 109 OVER WHITE RIVER BRIDGE SLAB REINFORCEMENT DETAILS NO. 1

DIVISION	STRUCTURES
JOB NO.	#2599
DESIGNED	JN
DRAWN	MD
CHECKED	TP
FILE	
DATE	7/7/23
SHEET NO	o.

S10

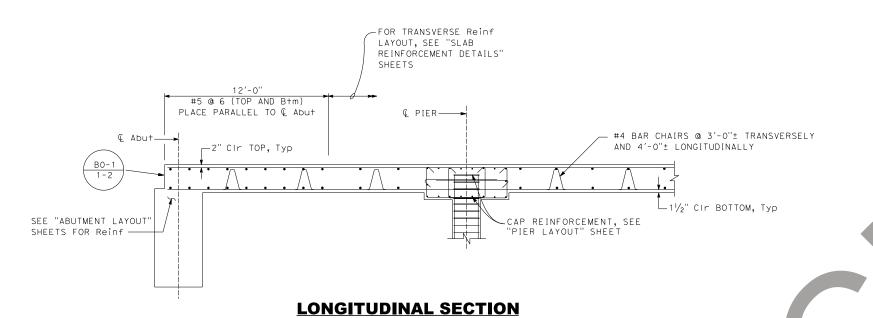


BARRIER NOT SHOWN FOR CLARITY -¾" CHAMFER TRANSVERSE SLAB Reinf #10 Cont Tot 4 -¾" CHAMFER 3/4" DRIP GROOVE-

EDGE OF SLAB DETAIL

REINFORCEMENT LAP SPLICE LENGTH Bar size #4 #5 #6 #7 #8 #9 #10 #11 23" 28" 34" 39" 45" 68" 76" 85" All bars, except top bars 23" 28" 34" 53" 60" 77" 97" 120" Top bars

Reinforcement notes:

Splices in top main bars to be located near center of span. Splices in bottom main bars to be located near piers. Spacing of all transverse bars is measured along "M" Line. Place all transverse bars normal to 'M' Line See details at right and below.

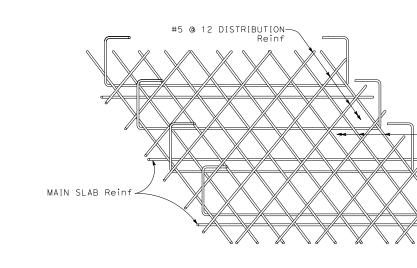

#4 BAR —

BAR CHAIR DETAIL

CAP STIRRUPS. PLACE PARALLEL TO MAIN SLAB Reinf AND SPACE ALONG © OF PIER. INTERIOR STIRRUPS NOT SHOWN FOR CLARITY

- CAP Reinf

CAP Reinf CAP STIRRUPS. PLACE- PARALLEL TO MAIN SLAB Reinf AND SPACE ALONG ©	#5 @ 12 — MAIN SLAB Reinf
OF PIER INTERIOR STIRRUPS NOT SHOWN FOR CLARITY	

TOP SLAB REINFORCEMENT AT PIER


BOTTOM SLAB REINFORCEMENT AT PIER

COUNTY OF TULARE
ESOURCE MANAGEMENT AGENCY
5961 SOUTH MONEY BLVD.
VISALIA, CA 93277
(559)624-7000
WWW.TULAECOUNT.CA,COV/RMA

MOUNTAIN ROAD 109
OVER WHITE RIVER
BRIDGE
SLAB REINFORCEMENT
DETAILS NO. 2

SCALE	AS SHOWN
DIVISION	STRUCTURES
JOB NO.	#2599
DESIGNED	JN
DRAWN	MD
CHECKED	TP
FILE	
DATE	7/7/23
SHEET NO	o. /
	. /

S11^{22 of} 27

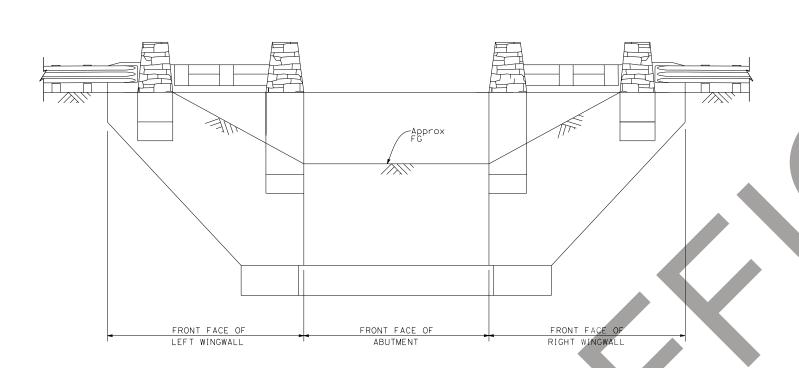

-CONCRETE SURFACE TEXTURE (DRY STACK) AND PREPARE AND STAIN CONCRETE (ALL FACES) -2'x2' BLOCKOUT FOR PLAQUE TILE

PLAQUE BLOCKOUT


PILASTER DETAILS NO SCALE


- 1. For locations of plaque blockout, see "GENERAL PLAN" sheet.
- 2. Concrete surface texture (dry stack) shall be Fitzgerald No. 17911 San Diego Drystack or equal

Note: Abutment 1 shown, Abutment 4 similar.

DEVELOPED ELEVATION NO SCALE

DENOTES CONCRETE SURFACE TEXTURE (DRY STACK)
AND PREPARE AND STAIN CONCRETE LIMITS

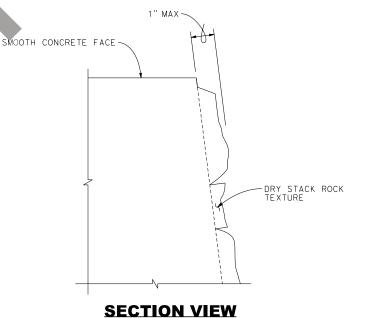

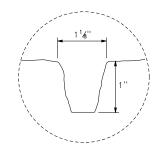

GROOVE DETAILS

The contractor shall verify all controlling field dimensions before ordering or fabricating any material.

DRY STACK ROCK TEXTURE DETAILS


COUNTY OF TULARE
RESOURCE MANAGEMENT AGENCY
5961 SOUTH MOONEY BLVD.
VISALIA, CA 93277
(S990824 - 00000)
www.TULARECOUNTY.CA.GOV/RMA



MOUNTAIN ROAD 109
OVER WHITE RIVER
BRIDGE
ARCHITECTURAL
TREATMENT DETAILS

SCALE AS SHOWN DIVISION STRUCTURES
JOB NO. #2599 DESIGNED JN MD CHECKED

S12

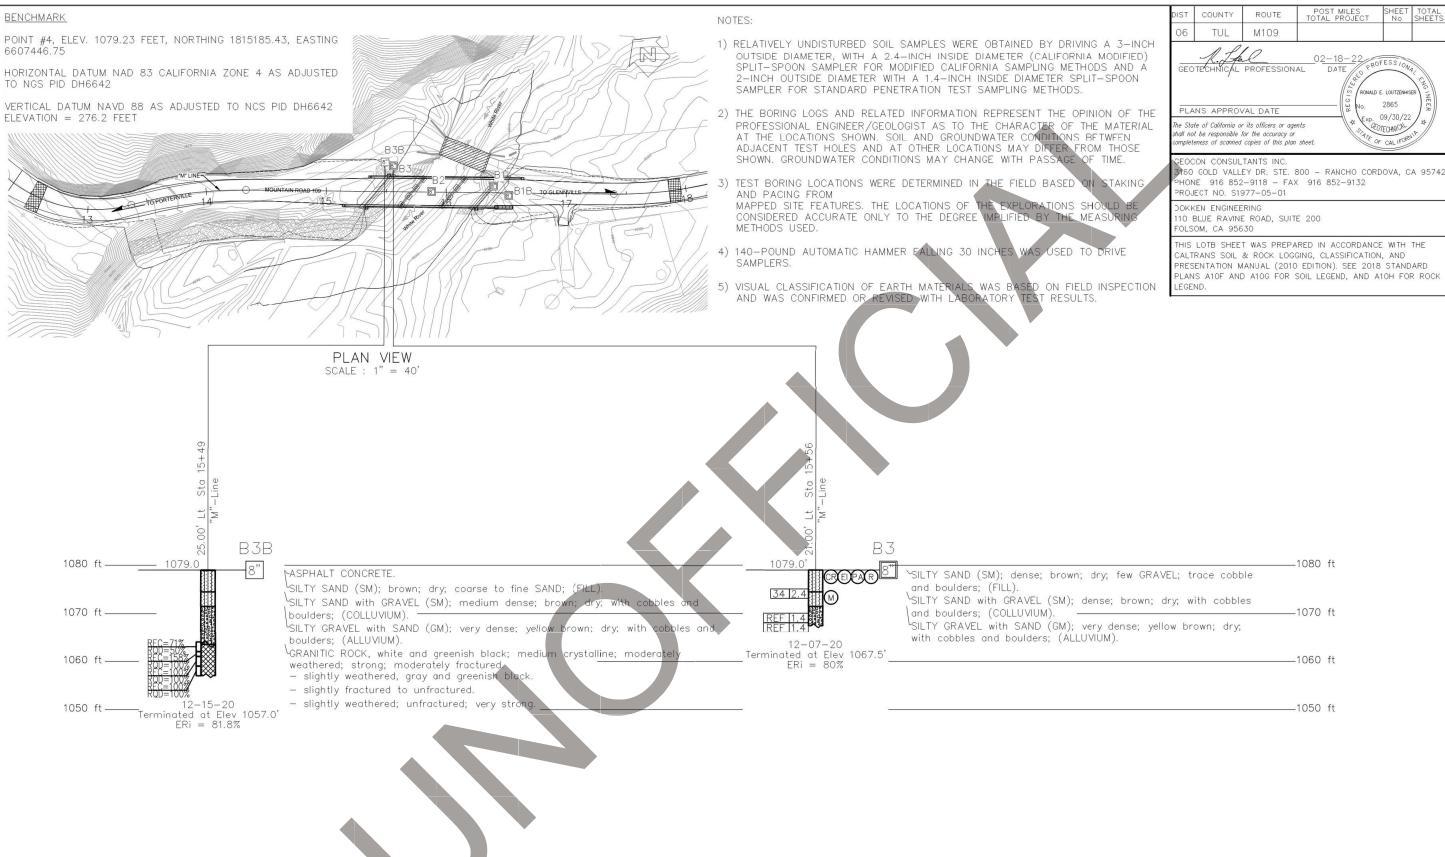

REVISIONS
DESCRIPTION
DATE BY

COUNTY OF TULARE
OURCE MANAGEMENT AGEN
S961 SOUTH MOONEY BLVD.
VISALIA. CA 93277
(\$59624-7000)
W.TULARECOUNTY.CA.GOV/RMA


0 - 7 F F R P - 7 G

MOUNTAIN ROAD 109
OVER WHITE RIVER
BRIDGE
OG OF TEST BORINGS No.

SCALE AS SHOWN
DIVISION STRUCTURES
JOB NO. #2599
DESIGNED JN
DRAWN MD
CHECKED TP
FILE
DATE 7/7/23
SHEET NO.

S13/

24 of 2'

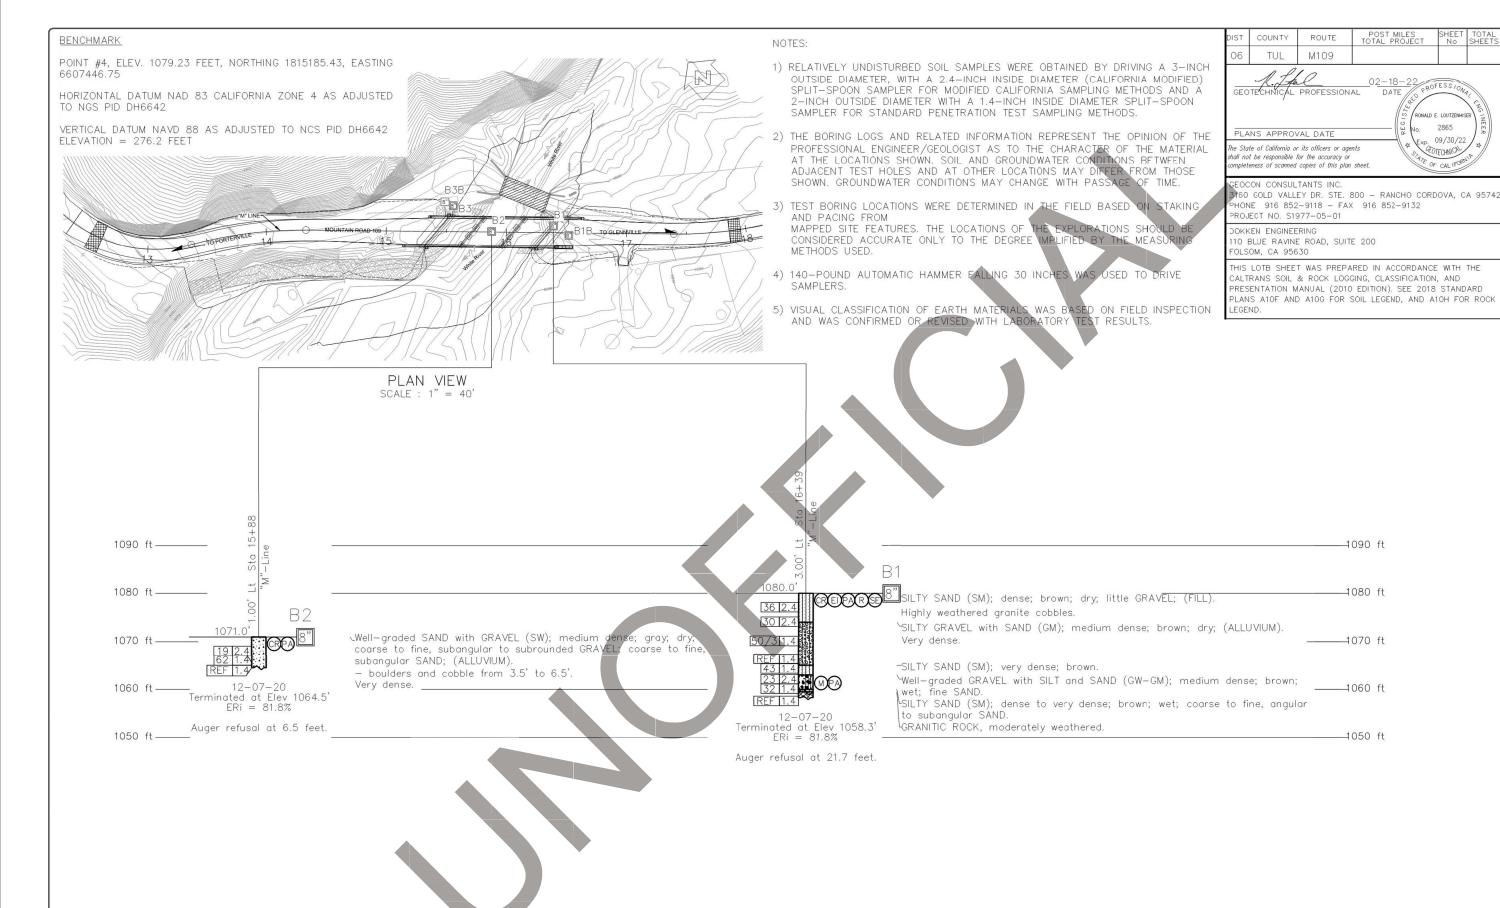

TOTAL


I SOUTH MOONEY E VISALIA, CA 93277 (559)624-7000 ULARECOUNTY.CA.GO

MOUNTAIN ROAD 109 OVER WHITE RIVER BRIDGE OF TEST BORINGS No.

SCALE AS SHOWN DIVISION STRUCTURES JOB NO. #2599 DESIGNED JN DRAWN MD CHECKED TP 7/7/23

DATE SHEET No.

S14

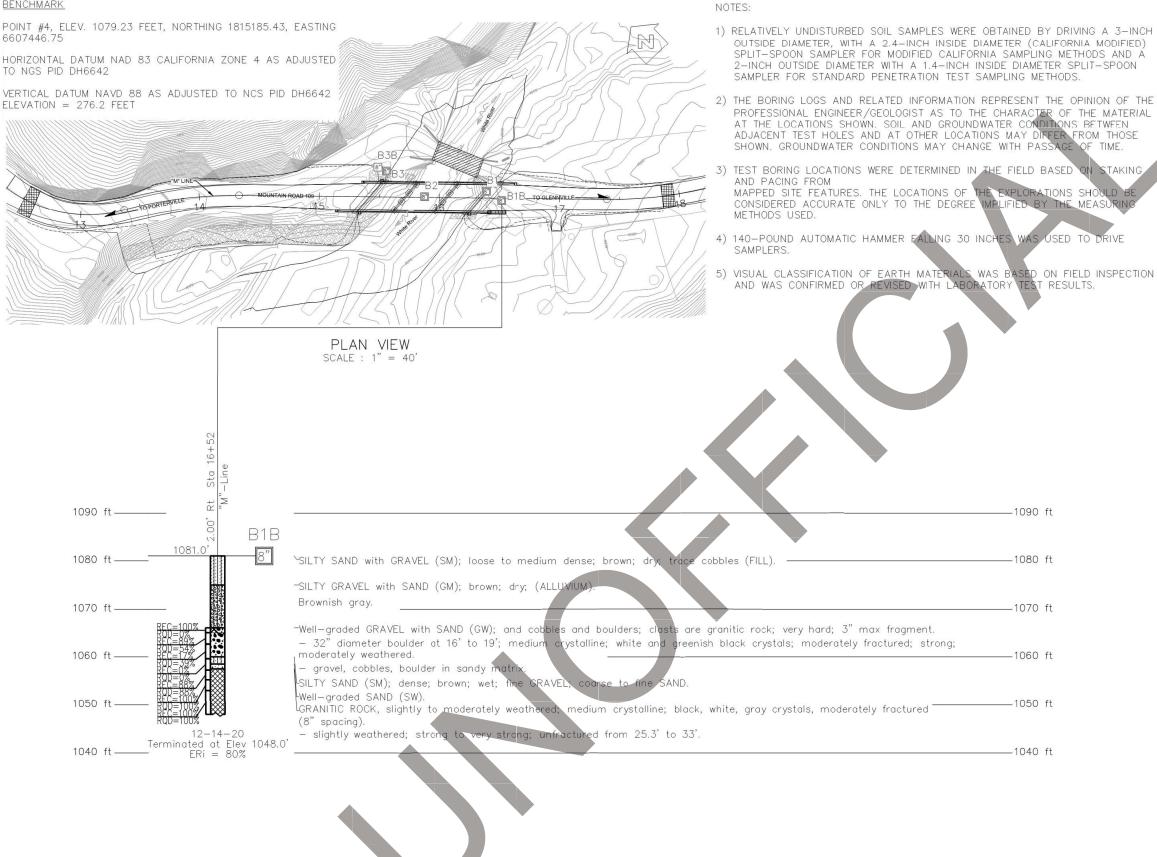

BENCHMARK

TUL M109 GEOTECHNICAL PROFESSIONAL DATE ONALD E. LOUTZENHIS 2865 PLANS APPROVAL DATE 09/30/22 The State of California or its officers or agents GEOTECHNICA) shall not be responsible for the accuracy or completeness of scanned copies of this plan sheet.

ROUTE

POST MILES TOTAL PROJECT

No No

EOCON CONSULTANTS INC 60 GOLD VALLEY DR. STE. 800 - RANCHO CORDOVA, CA 95742 HONE 916 852-9118 - FAX 916 852-9132 PROJECT NO. S1977-05-01

DOKKEN ENGINEERING 110 BLUE RAVINE ROAD, SUITE 200 FOLSOM, CA 95630

COUNTY

THIS LOTB SHEET WAS PREPARED IN ACCORDANCE WITH THE CALTRANS SOIL & ROCK LOGGING, CLASSIFICATION, AND PRESENTATION MANUAL (2010 EDITION). SEE 2018 STANDARD PLANS A10F AND A10G FOR SOIL LEGEND, AND A10H FOR ROCK

TOTAL

SOUTH MOO VISALIA, CA 9 (559)624-7 JLARECOUNTY.



MOUNTAIN ROAD 109 OVER WHITE RIVER BRIDGE TEST BORINGS No. . НО

SCALE AS SHOWN DIVISION STRUCTURES JOB NO. DESIGNED JN DRAWN MD CHECKED TP 7/7/23 DATE SHEET No.

S15

